CITY OF GREENVILLE
WAYFINDING AND SIGNAGE PROGRAM
CONSTRUCTION DOCUMENTATION PACKAGE

September 1, 2010 Revision: January 31, 2011

City of Greenville Greenville, NC

Project No. 41-07984.000



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Suite 208
West Chester, PA 19380
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www.merjedesign.com

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		August	6 2010
		Y41-07984.000	

SECTION 1 | Signage Drawings

A. Graphic Standards

PRIMARY TYPEFACE

Clearview Highway -2W ABCDEFGHIJKLMNOPQRSTUVWXYZ abcdefghijklmnopqrstuvwxyz 1234567890 ''!@#\$%^

Amongst the several mechanical Arts that have engaged my attention, there is no one which I have pursued with so much steadiness and pleasure, as that of Letter Founding.

Library Lik

Library Library

NOT acceptable NOT acceptable

123A acceptable

123A

123A

NOT acceptable

NOT acceptable

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Structural Consulting Engineers
1180 Welsh Rd, Suite 190
North Wales. PA 19454

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SPECIFICATIONS

The Contractor must submit a full alphabet of 1" letters and numerals.

All type shall be set exactly as specified. Substitutions will only be accepted, at the Client's or Designer's discretion, where they match the specified typeface in every detail. The Contractor shall be aware that different versions of typesetting equipment may not satisfactorily match specified type faces and in such instances will not be acceptable.

Sometimes the Foot mark is mistaken for an apostrophe and an inch mark is mistaken for quotations. Below are examples of correct and incorrect apostrophe's for each typeface.

CLEARVIEW HWY 2-W



This apostrophe is CORRECT.

PARK'S



This apostrophe is INCORRECT.

PARK'S

DESIGN NOTE:

Final design and shop drawings shall be supplied by the fabricator. North Carolina registered professional engineer is required to sign and seal the submittal of shop drawings.

NOTES

CLIENT / PROJECT ENVIRONMENTS & EXPERIENCES City of Greenville, NC 120 North Church Street City of Greenville, NC Wayfinding and Signage West Chester, PA 19380 T 484 266 0648 www.meriedesign.com PROJECT NO. Y41-07963 SUBCONSULTANT SHEET TITLE 6/30/2009 KB/GS Typography REVISIONS hese drawings are meant for DESIGN INTENT ONLY **Specifications** and are not for construction. Contractor shall verify and be responsible for all dimensions and conditio of the job. Contractor shall be familiar with the site 05/22/2010 and conditions it presents. This office must be noti-SHEET NO. fied of any variations from the dimensions and cond 08/06/2010 tions shown on this drawing. Shop drawings and **A.1** prior to proceeding with fabrication. All copy shall be 09/01/2010 proofread by client and legal requirements checked 01/31/2011

SECONDARY TYPEFACE

Rawlinson Regular ABCDEFGHIJKLMNOPQRSTUVWXYZ abcdefghijklmnopqrstuvwxyz 1234567890 ''!@#\$%^

Amongst the several mechanical Arts that have engaged my attention, there is no one which I have pursued with so much steadiness and pleasure, as that of Letter Founding.

Library Library Library NOT acceptable NOT acceptable

123A 123A 123A 123A NOT acceptable NOT acceptable

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Sometimes the Foot mark is mistaken for an apostrophe and an inch mark is mistaken for quotations. Below are examples of correct and incorrect apostrophe's for each typeface.

RAWLINSON REGULAR



This apostrophe is CORRECT.

PARK'S



DESIGN NOTE:

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NOTES



LETTER SPACING

Inconsistencies in Letter Spacing

Corrected Letter Spacing

TYPEFACE 1

TYPEFACE 1

Greenville

Greenville

IMPORTANT: Individual spacing of each letter needs to be evaluated. See Examples Above. Kern all Copy so that each character is optically centered between the center of each of the surrounding characters.

ARROWS AND TEXT RELATIONSHIPS

Always measure from baselline to baseline. Please Reference to the arrow detail below.



COPY HEIGHT

When measuring copy height, measure only the height of the Capital letters to determine your overall copy height shown in illustration below as "X." Some of the other letters have an extended height beyond the average height of the letters.



LINE SPACING

When measuring line spacing, always measure from the baseline of the top most text line to the baseline of the text line below shown as "X."



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SPECIFICATIONS

ALL TYPE SHALL BE SET EXACTLY AS SPECIFIED.

Individual spacing of each letter shall be evaluated and approved by the DESIGNER and CLIENT prior to sign fabrication. All copy shall be kerned so that each character is optically centered between the center of each of the surrounding characters.

DESIGN NOT

Final design and shop drawings shall be supplied by the fabricator. North Carolina registered professional engineer is required to sign and seal the submittal of shop drawings.

NOTES

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Districts

Uptown District

Medical **District**

Convention **District**

Education

ECU

ECU Main Campus

ECU Stadiums

P.C.C. Main Campus

P.C.C. Greenville Ctr.

Rose High School

Government

City Hall Courthouses County Admin. Office

Historic & Tourism

Chamber of Commerce

Convention Center

Visitor Center NAACP

Transportation

Airport

Arts & Cultural

G.W. Carver **Branch Library**

Museum of Art

Ampitheater

East Branch Library

Sheppard Mem. Library

Five Points Plaza

Parking

Public Parking City Hall Parking

Other

Industrial Park

Hospitals

Hospital

Parks & Recreation

Science and **Nature Center**

Town Common

Thomas Foreman Park

- **Green Springs** Park
- Elm St. Park
- Jaycee Park
- **Peppermint** Park
- **Evans Park**
- Boyd Lee Park

City

Tarboro

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merje 6/30/2009

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> West Chester, PA 19380 T 484.266.0648

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Y41-07963

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KB/GS **Word Breaks**

SPECIFICATIONS

Terminology Shown represents Graphic Breaks for Vehicular Directional Signs with 4"

ALL TYPE SHALL BE SET EXACTLY AS SPECIFIED.

City of Greenville, NC

CLIENT / PROJECT

City of Greenville, NC Wavfinding and Signage

Final design and shop drawings shal be supplied by the fabricator. North

engineer is required to sign and sea

Carolina registered professiona

the submittal of shop drawings

PROJECT NO. SHEET TITLE

REVISIONS 05/22/2010 SHEET NO. 08/06/2010

A.4

Phone 215-855-8713 Fax 215-855-8714

* Potential Future - Vehicular Destinations



Leaf Symbol



Uptown Logo

uptown convention medical

Medical District Logo

Convention District Logo

ARROWS



Left Arrow



Up-Left Arrow



Straight Arrow



Up-Right Arrow



Right Arrow



Straight-Left Arrow

Up-Straight-Left Arrow



Up-Straight-Right Arrow

Straight-Right Arrow

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USE of Arrows

When multiple directions are required on a sign, the following directional hierarchy shall take precedent. See Example below. Reference Message Schedule for individual Messages.



Straight Arrow



Left Arrow



Right Arrow

DESIGN NOTE:

Final design and shop drawings shall be supplied by the fabricator. North Carolina registered professional engineer is required to sign and seal the submittal of shop drawings.

NOTES

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P PAINTS	NAME	SPECIFICATION	PROCESS
P1	Dark Blue	Paint to match Pantone 654C	Surface painted, plus UV/ Anti Graffiti Clear Coat Protectant
P2	Dark Green	Paint to match Pantone 554C	Surface painted, plus UV/ Anti Graffiti Clear Coat Protectant
P3	Light Green	Paint to match Pantone 376C	Surface painted, plus UV/ Anti Graffiti Clear Coat Protectant
P4	Dark Red	Paint to match Pantone 483C	Surface painted, plus UV/ Anti Graffiti Clear Coat Protectant
P5	Silver	Matthews Paint "Brushed Aluminum"	Surface painted, plus UV/ Anti Graffiti Clear Coat Protectant
P6	Bronze	Matthews Paint MP 8672	Surface painted, plus UV/ Anti Graffiti Clear Coat Protectant
P7	Black	Matthews Paint MP 19962	Surface painted, plus UV/ Anti Graffiti Clear Coat Protectant
P8	Gray	Matthews Paint MP 18238	Surface painted, plus UV/ Anti Graffiti Clear Coat Protectant
P9	White	Matthews Paint "White"	Surface painted, plus UV/ Anti Graffiti Clear Coat Protectant
P10	Light Blue	Matthews Paint Color Match: Pantone 314C	Surface painted, plus UV/ Anti Graffiti Clear Coat Protectant
V VINYLS	1	1	
V1	Dark Blue Reflective	3M High Intensity Prismatic Reflective Sheeting 3930 Color Match: Pantone 654C	Custom Color: Screenprinted Background and Characters 3M custom inks direct to 3930 with 3M approved UV/Graffiti Vinyl Over-laminates.
V2	Dark Green Reflective	3M High Intensity Prismatic Reflective Sheeting 3930 Color Match: Pantone 554C	Custom Color: Screenprinted Background and Characters 3M custom inks direct to 3930 with 3M approved UV/Graffiti Vinyl Over-laminates.
V3	Light Blue Reflective	3M High Intensity Prismatic Reflective Sheeting 3930 Color Match: Pantone 314C	Custom Color: Screenprinted Background and Characters 3M custom inks direct to 3930 with 3M approved UV/Graffiti Vinyl Over-laminates.
V4	Silver	3M Opaque Vinyl 3M 180C-220 "Light Silver Metallic"	3M approved UV/Graffiti Vinyl Over-laminates.
V5	White Reflective	3M High Intensity Prismatic Reflective Sheeting Color: 3930 "White"	3M approved UV/Graffiti Vinyl Over-laminates.
V6	White	3M Opaque Vinyl Color: 180C-10 "White"	3M approved UV/Graffiti Vinyl Over-laminates.
V7	Light Green	3M Opaque Vinyl Color Match: Pantone 376C	3M approved INKS with UV/Graffiti Vinyl Over-laminates.
V8	DOT Green Reflective	3M High Intensity Prismatic Reflective Sheeting Color: 3937	Standard Color: Screenprinted Background and Characters 3M standard inks direct to 3930 with 3M approved UV/Graffiti Vinyl Over-laminates.
V9	DOT Blue Reflective	3M High Intensity Prismatic Reflective Sheeting Color: 3935	Standard Color: Screenprinted Background and Characters 3M standard inks direct to 3930 with 3M approved UV/Graffiti Vinyl Over-laminates.
V10	Gray	3M Opaque Vinyl Color: 180C-31 "Medium Gray"	3M approved UV/Graffiti Vinyl Over-laminates.

NOTE: All 3M products are to be processed and applied according to 3M specifications. The seaming of material is not preferred. If the height of a sign panel is greater then 48 inches, the 3M 3930 material should be oriented vertically with stripes at 0 degrees, to avoid the seaming of material. If seaming is required, it should occur at the rule line or between messages.

SPECIFICATIONS

The Contractor shall submit 2 identical sets of each color specified for approval to the client prior to any painting. Sample swatches are to be produced on the substrate material of the final product.

The colors must look exactly the same every time they are used so that people associate them with the City of Greenville, NC. All media, vinyl, paint, and inks must be produced so that the colors match as specified on this page.

DESIGN NOTE:

CLIENT / PROJECT

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NOTES

merje

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6/30/2009

DRAWN BY: KB/GS

REVISIONS

05/22/2010

08/06/2010

09/01/2010

01/31/2011

SHEET TITLE Y41-07963

Clty of Greenville, NC

City of Greenville, NC

Wayfinding and Signage

Color Chart

SHEET NO.

A.6

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B. Menu of Sign Types






Scale: 1/4" = 1'-0"

GATE.1

GATE.2

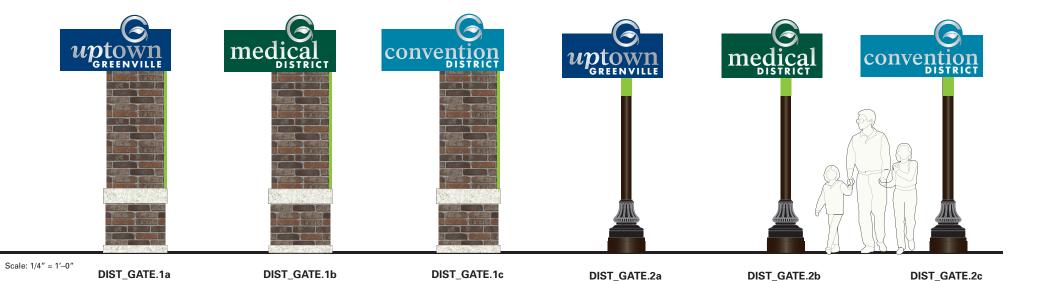

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SPECIFICATIONS

City Gateway GATE.1 GATE.2

District Gateway

DIST_GATE.1A DIST_GATE.1B DIST_GATE.1C DIST_GATE.2A DIST_GATE.2B DIST_GATE.2C

Upon installation of the sign, the fabricator shall cover the sign with a white vinyl bag, with drawstrings or other method of attachment and closure. The City of

Greenville logo (1 color) shall be silkscreened on the outside of the bag.

- 1. All signs shall be covered until accepted by the City of Greenville
- 2. Installer is responsible for removal of all bags within 24 hours of acceptance.
- 3. Designer will supply Logo artwork and layout.


DESIGN NOTE:


Final design and shop drawings shall be supplied by the fabricator. North Carolina registered professional engineer is required to sign and seal the submittal of shop drawings.

NOTES

Sign Types shown on this page represent the entire wayfinding system. Not all sign types may be built concurrently and may be bid in phases, please reference the sign location plan/message schedule and bid form for quantities.

CLIENT / PROJECT ENVIRONMENTS & EXPERIENCES City of Greenville, NC 120 North Church Street City of Greenville, NC Suite 208 **Wayfinding and Signage** West Chester, PA 19380 T 484.266.0648 www.merjedesign.com PROJECT NO. Y41-07963 SHEET TITLE SUBCONSULTANT DRAWN BY: 6/30/2009 KB/GS Sign Menu REVISIONS These drawings are meant for DESIGN INTENT ONLY Gateways and are not for construction. Contractor shall verify and be responsible for all dimensions and condition of the job. Contractor shall be familiar with the site 05/22/2010 and conditions it presents. This office must be noti-SHEET NO. fied of any variations from the dimensions and cond 08/06/2010 tions shown on this drawing. Shop drawings and details must be submitted to this office for approval **B.1** prior to proceeding with fabrication. All copy shall be 09/01/2010 proofread by client and legal requirements checked y legal department. 01/31/2011

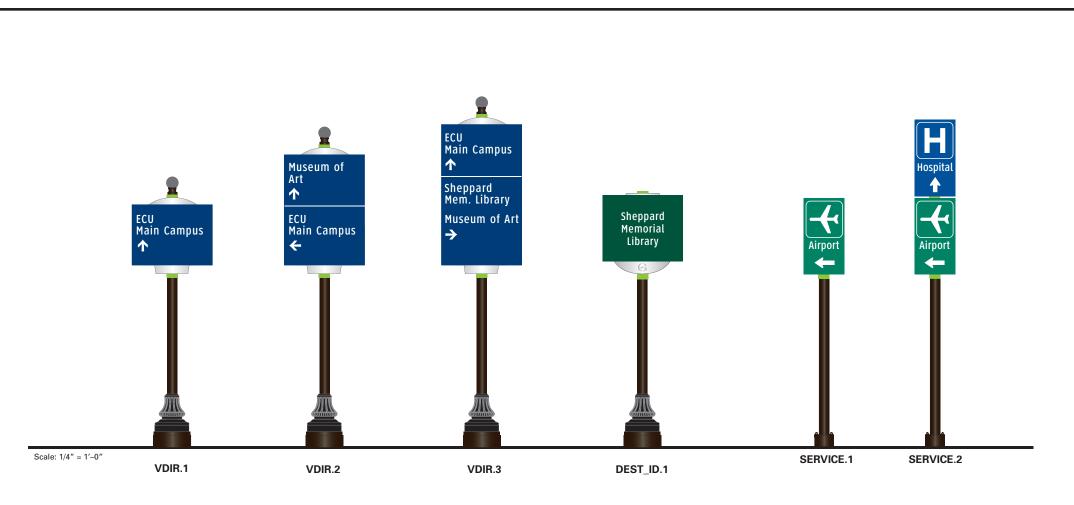

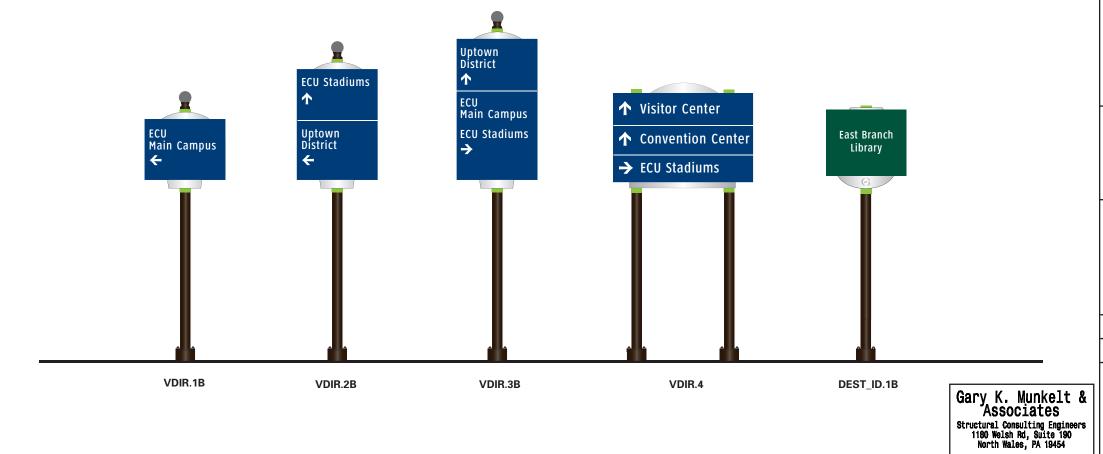

SPECIFICATIONS

Destination Arrival

DEST_ID.1 DEST_ID.1B

Service Trailblazers

SERVICE.1 SERVICE.2

Vehicular Directional - Uptown

VDIR.1 VDIR.2 VDIR.3

Vehicular Directional

VDIR.1B VDIR.2B VDIR.3B VDIR.4

Upon installation of the sign, the fabricator shall cover the sign with a white vinyl bag, with drawstrings or other method of attachment and closure. The City of

| 4

Greenville logo (1 color) shall be silkscreened on the outside of the bag.

- 1. All signs shall be covered until accepted by the City of Greenville
- 2. Installer is responsible for removal of all bags within 24 hours of acceptance.
- 3. Designer will supply Logo artwork and layout.

DESIGN NOTE:


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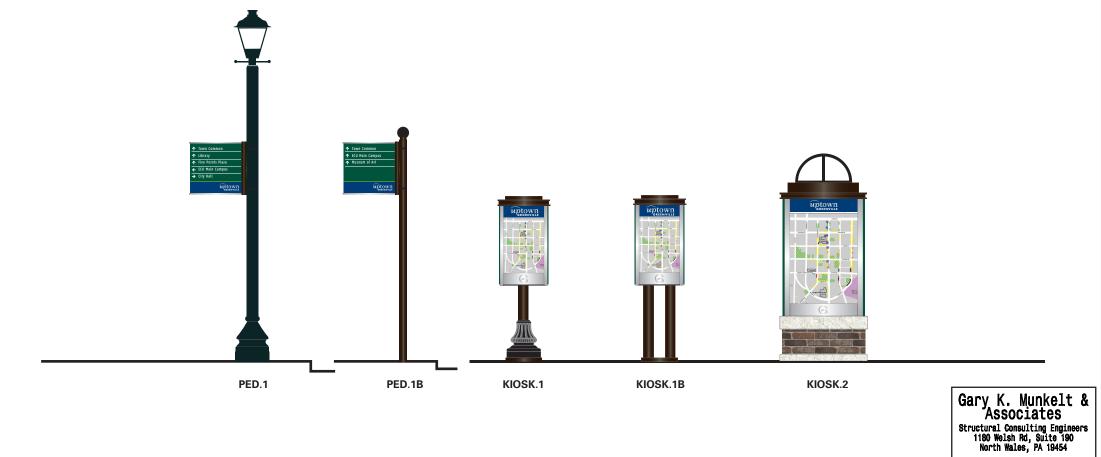
NOTES

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SPECIFICATIONS

Parking Directionals

PARK.1 PARK.2

PARK.3

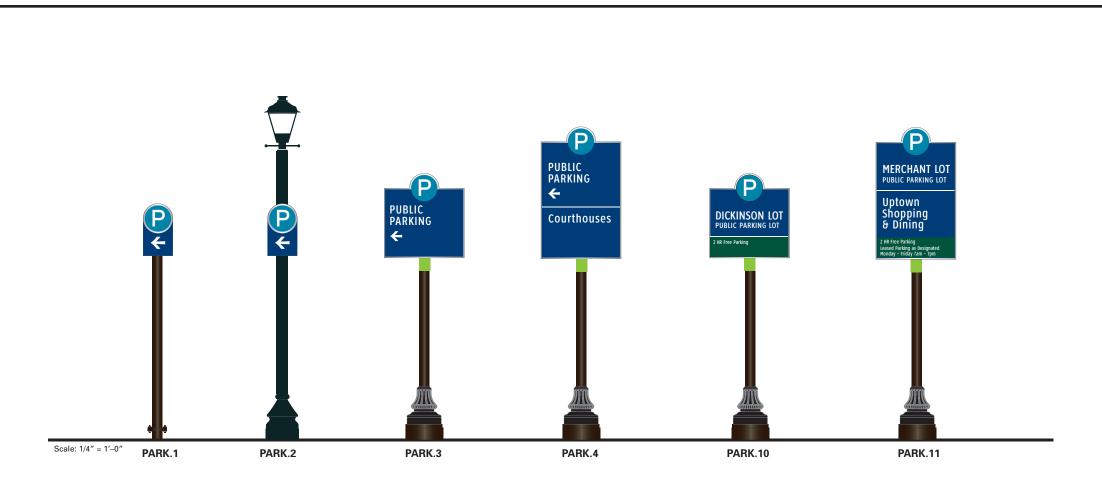PARK.4

Parking Identification

PARK.10 PARK.11

Pedestrian Directionals

PED.1B

Pedestrian Kiosks

KIOSK.1

KIOSK.1B

KIOSK.2

Upon installation of the sign, the fabricator shall cover the sign with a white vinyl bag, with drawstrings or other method of attachment and closure. The City of

Greenville logo (1 color) shall be silkscreened on the outside of the bag.

- 1. All signs shall be covered until accepted by the City of Greenville
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- 3. Designer will supply Logo artwork and

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09/01/2010

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CLIENT / PROJECT

City of Greenville, NC City of Greenville, NC **Wayfinding and Signage**

PROJECT NO. Y41-07963

SHEET TITLE

DRAWN BY: KB/GS Sign Menu REVISIONS Parking & Pedestrian 05/22/2010 SHEET NO. fied of any variations from the dimensions and condi 08/06/2010 tions shown on this drawing. Shop drawings and details must be submitted to this office for approval

B.3

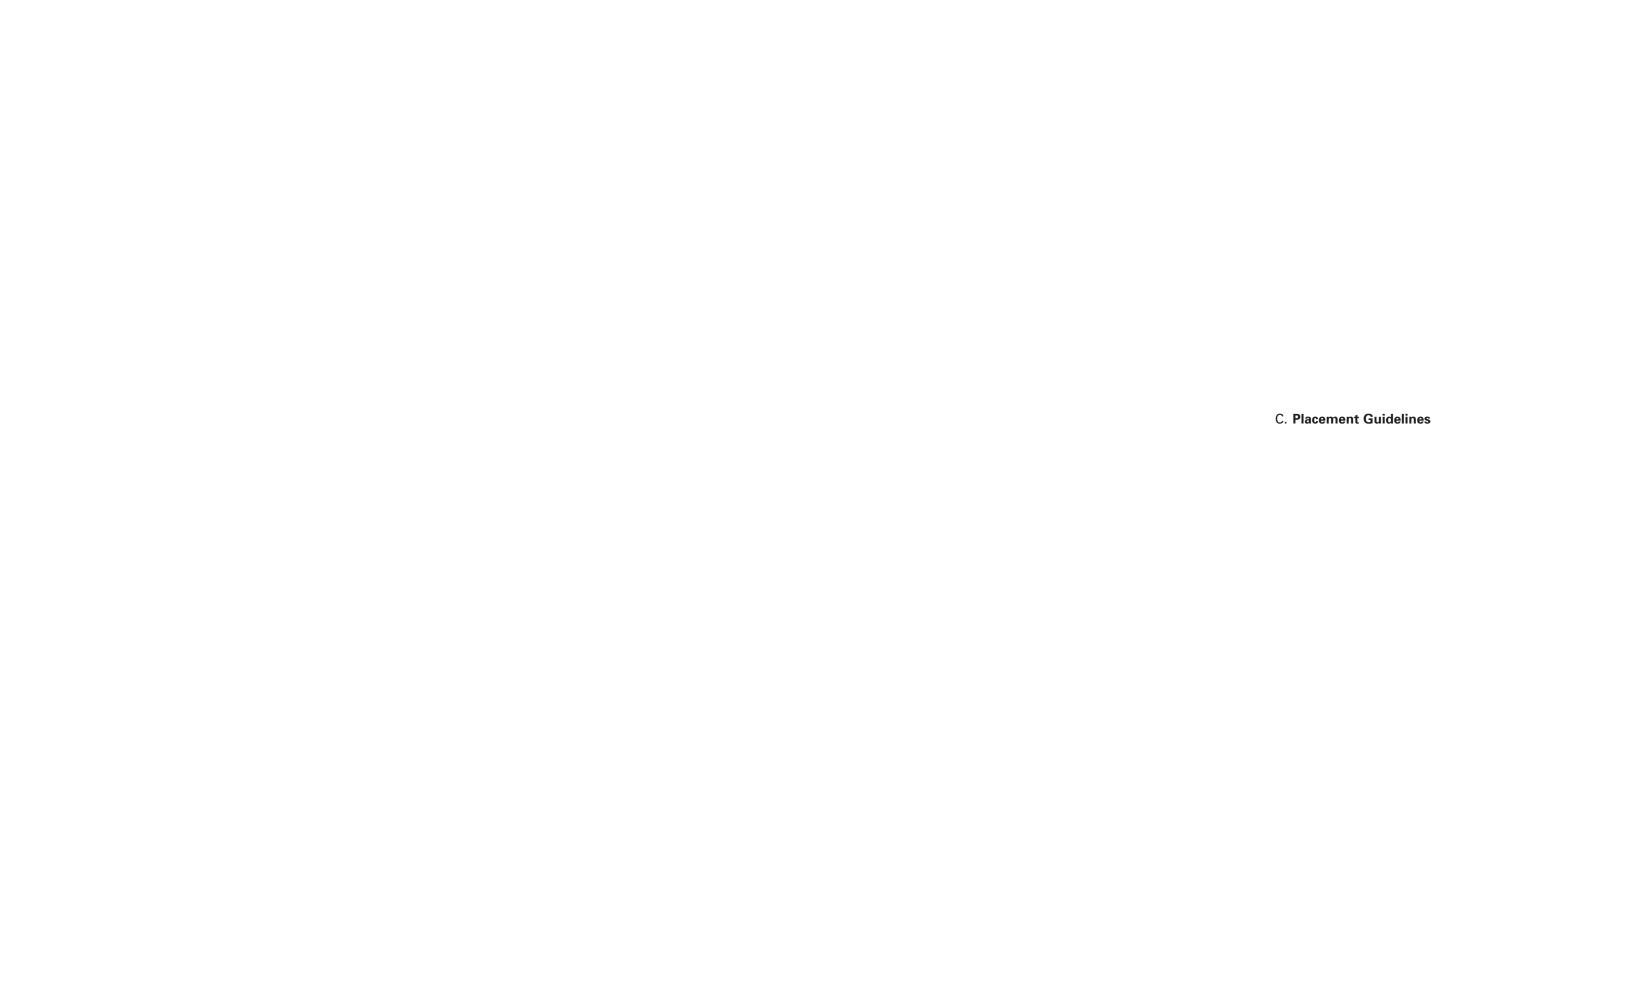


Figure 1

Sign A: VDIR.1-VDIR.4, SERVICE.1-SERVICE.2


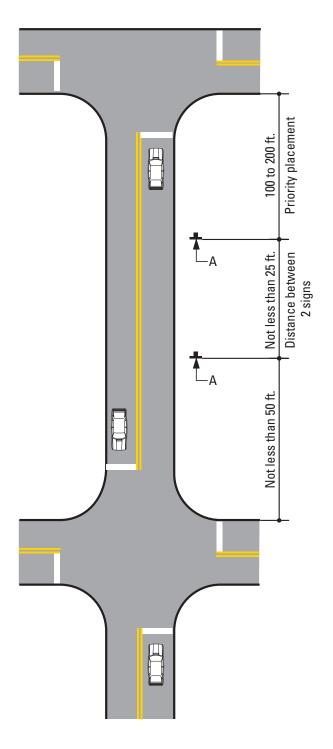


Figure 2

Sign C: PARK.1-PARK.4 Sign D: PARK.10-PARK.11

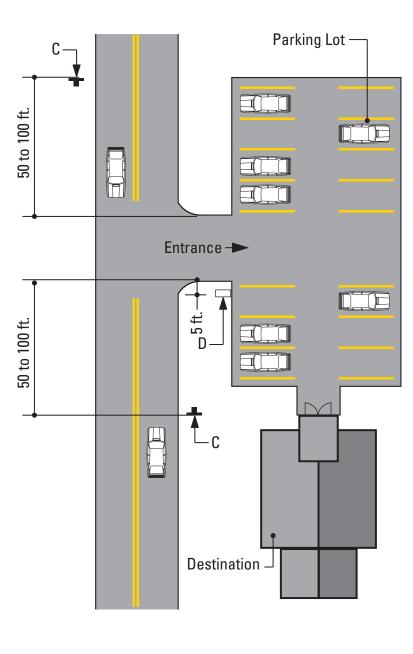

SPECIFICATIONS

FIGURE 1- Vehicular Directuional - Sign Placement Guideline FIGURE 2 - Parking - Sign Placement Guideline

Unless approved by the Client or its designated agent, all signs shall be installed to the right of the direction of traffic and where sufficient space is available.

- (a) Signs shall be located to take advantage of natural terrain, to minimize impacts on scenic environment and to avoid visual conflicts with other signs, trees and lampposts within the City right-of-way.
- (b) Signs shall be located so as not to interfere with, obstruct or divert driver's attention from any other Official Traffic Control Device. Other Official Traffic Control Devices placed at intersection approaches, subsequent to the placement of a Wayfinding Sign, shall have precedence as to location and may require the relocation of the Wayfinding Sign. In the locations where Official Traffic Control Devices are integrated into the Wayfinding Signage System, the Official Traffic Control Devices shall take precedence with regard to order, space and location, over other information.
- (c) Wayfinding Signs shall be positioned in such a manner that does not restrict driver's attention or view when making turns or driving through an intersection.
- (d) There shall be a goal of one sign per block, although two are permissible, where necessary.

The following pages illustrate installation guidelines for the location and spacing of the various sign types. Figures 1 through 6 represent the guidelines for the location of the various sign types, while Figure 7 illustrates the lateral clearance guidelines.

DESIGN NOTE:

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NOTES

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01/31/2011

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Figure 3

Sign E: DESTID.1-DESTID.1b


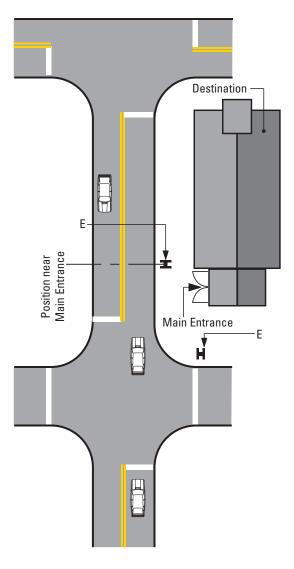


Figure 4

Sign A: VDIR.1-VDIR.4, SERVICE.1-SERVICE.2

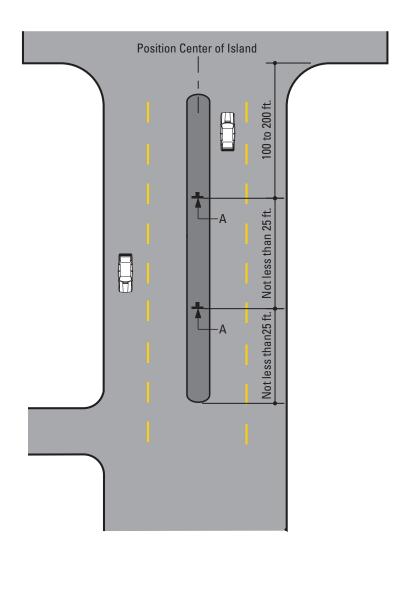

SPECIFICATIONS

FIGURE 3- Destination Arrival-Vehicular/Pedestrian - Sign Placement Guideline FIGURE 4 - Vehicular Directuional - Sign Placement Guideline

Unless approved by the Client or its designated agent, all signs shall be installed to the right of the direction of traffic and where sufficient space is available.

- (a) Signs shall be located to take advantage of natural terrain, to minimize impacts on scenic environment and to avoid visual conflicts with other signs, trees and lampposts within the City right-of-way.
- (b) Signs shall be located so as not to interfere with, obstruct or divert driver's attention from any other Official Traffic Control Device. Other Official Traffic Control Devices placed at intersection approaches, subsequent to the placement of a Wayfinding Sign, shall have precedence as to location and may require the relocation of the Wayfinding Sign. In the locations where Official Traffic Control Devices are integrated into the Wayfinding Signage System, the Official Traffic Control Devices shall take precedence with regard to order, space and location, over other information.
- (c) Wayfinding Signs shall be positioned in such a manner that does not restrict driver's attention or view when making turns or driving through an intersection.
- (d) There shall be a goal of one sign per block, although two are permissible, where necessary.

The following pages illustrate installation guidelines for the location and spacing of the various sign types. Figures 1 through 6 represent the guidelines for the location of the various sign types, while Figure 7 illustrates the lateral clearance guidelines.

DESIGN NOTE:

Final design and shop drawings shall be supplied by the fabricator. North Carolina registered professional engineer is required to sign and seal the submittal of shop drawings.

NOTES

CLIENT / PROJECT ENVIRONMENTS & EXPERIENCES Clty of Greenville, NC 120 North Church Street City of Greenville, NC Suite 208 **Wayfinding and Signage** West Chester, PA 19380 T 484.266.0648 www.merjedesign.com PROJECT NO. Y41-07963 SHEET TITLE SUBCONSULTANT DRAWN BY: 6/30/2009 KB/GS Sign Placement REVISIONS These drawings are meant for DESIGN INTENT ONLY Guidelines and are not for construction. Contractor shall verify and be responsible for all dimensions and condition of the job. Contractor shall be familiar with the site 05/22/2010 and conditions it presents. This office must be noti-SHEET NO. fied of any variations from the dimensions and cond 08/06/2010 tions shown on this drawing. Shop drawings and details must be submitted to this office for approval **C.2** prior to proceeding with fabrication. All copy shall be 09/01/2010 proofread by client and legal requirements checked 01/31/2011

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1180 Welsh Rd, Suite 190
North Wales, PA 19454

Figure 5

Sign B: GATE.2a to GATE.2c


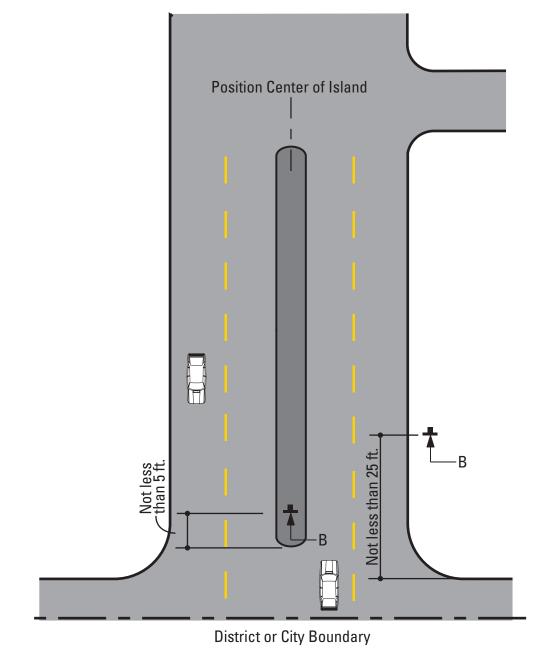


Figure 6

Sign A: VDIR.1 to VDIR.4, SERVICE.1-SERVICE.2

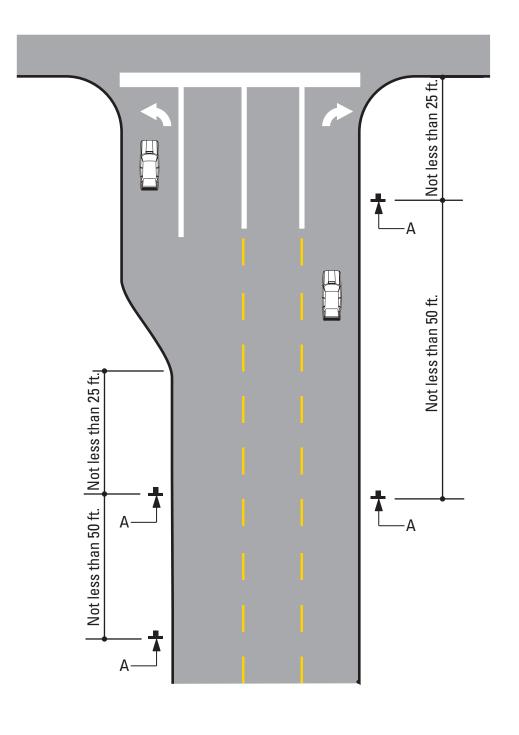

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SPECIFICATIONS

FIGURE 5- Gateway/District Arrival-Vehicular - Sign Placement Guideline FIGURE 6 - Vehicular Directional - Sign Placement Guideline

Unless approved by the Client or its designated agent, all signs shall be installed to the right of the direction of traffic and where sufficient space is available.

- (a) Signs shall be located to take advantage of natural terrain, to minimize impacts on scenic environment and to avoid visual conflicts with other signs, trees and lampposts within the City right-of-way.
- (b) Signs shall be located so as not to interfere with, obstruct or divert driver's attention from any other Official Traffic Control Device. Other Official Traffic Control Devices placed at intersection approaches, subsequent to the placement of a Wayfinding Sign, shall have precedence as to location and may require the relocation of the Wayfinding Sign. In the locations where Official Traffic Control Devices are integrated into the Wayfinding Signage System, the Official Traffic Control Devices shall take precedence with regard to order, space and location, over other information.
- (c) Wayfinding Signs shall be positioned in such a manner that does not restrict driver's attention or view when making turns or driving through an intersection.
- (d) There shall be a goal of one sign per block, although two are permissible, where necessary.


The following pages illustrate installation guidelines for the location and spacing of the various sign types. Figures 1 through 6 represent the guidelines for the location of the various sign types, while Figure 7 illustrates the lateral clearance guidelines.

DESIGN NOTE:

Final design and shop drawings shall be supplied by the fabricator. North Carolina registered professional engineer is required to sign and seal the submittal of shop drawings.

NOTES

CLIENT / PROJECT ENVIRONMENTS & EXPERIENCES Clty of Greenville, NC 120 North Church Street City of Greenville, NC Suite 208 **Wayfinding and Signage** West Chester, PA 19380 T 484.266.0648 www.merjedesign.com PROJECT NO. Y41-07963 SHEET TITLE SUBCONSULTANT DRAWN BY: 6/30/2009 KB/GS Sign Placement REVISIONS These drawings are meant for DESIGN INTENT ONLY **Guidelines** and are not for construction. Contractor shall verify and be responsible for all dimensions and condition of the job. Contractor shall be familiar with the site 05/22/2010 and conditions it presents. This office must be noti-SHEET NO. fied of any variations from the dimensions and cond 08/06/2010 tions shown on this drawing. Shop drawings and details must be submitted to this office for approval **C.3** prior to proceeding with fabrication. All copy shall be 09/01/2010 proofread by client and legal requirements checked

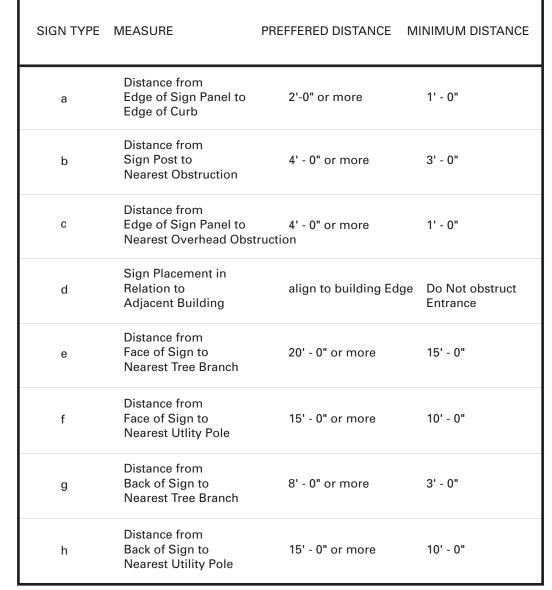

Measurements and Distances shown are guidelines only prevailing local and state codes shall supersede information presented.

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North Wales, PA 19454

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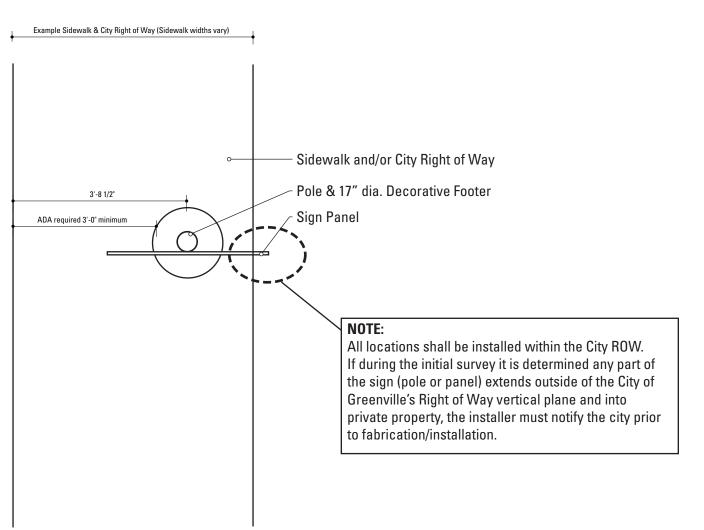
DESIGN NOTE: Final design and shop drawings shall be supplied by the fabricator. North Carolina registered professional engineer is required to sign and seal

the submittal of shop drawings.

NOTES

SPECIFICATIONS





SIGN TYPE E	ISTANCE DGE OF CURB to DGE OF SIGN FANEL	DISTANCE TO CENTER OF POST
DEST_ID.1-1B	2'-0"	3'-8"
DEST_ID.1-1B	1'-6"	3'-2"
DEST_ID.1-1B	1'-0"	2'-8"
DIST_GATE.1-2A-B	2'-0"	5'-2 1/2"
DIST_GATE.1-2A-B	1'-6"	4'-8 1/2"
DIST_GATE.1-2A-B	1'-0"	4'-2 1/2"
DIST_GATE.1-2C	2'-0"	5'-8 1/2"
DIST_GATE.1-2C	1'-6"	5'-2 1/2"
DIST_GATE.1-2C	1'-0"	4'-8 1/2"
GATE.2	2'-0"	5'-1 3/8"
GATE.2	1'-6"	4'-7 3/8"
GATE.2	1'-0"	4'-1 3/8"
PARK.1	2'-0"	2'-7 1/2"
PARK.1	1'-6"	2'-1 1/2"
PARK.1	1'-0"	1'-7 1/2"
PARK.3-4	2'-0"	3'-8"
PARK.3-4	1'-6"	3'-2"
PARK.3-4	1'-0"	2'-8"
PARK.10-11	2'-0"	3'-8"
PARK.10-11	1'-6"	3'-2"
PARK.10-11	1'-0"	2'-8"
SERVICE.1-2	2'-0"	2'-9 3/4"
SERVICE.1-2	1'-6"	2'-3 3/4"
SERVICE.1-2	1'-0"	1'-9 3/4"
VDIR.1-3	2'-0"	3'-8"
VDIR.1-3	1'-6"	3'-2"
VDIR.1-3	1'-0"	2'-8"
VDIR.1B-3B	2'-0"	3'-8"
VDIR.1B-3B	1'-6"	3'-2"
VDIR.1B-3B	1'-0"	2'-8"

Reference View: Example - 5 foot Sidewalk / City Right of Way

SCALE: 1/2" = 1'-0"

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SPECIFICATIONS Final design and shop drawings shall be supplied by the fabricator. North Carolina registered professional engineer is required to sign and seal

NOTES


Fabricator shall verify the mounting conditions and provide a detail drawing for each mounting situation, prior to fabrication.
 Fabricator shall obtain approval from the Designer or Client for placement prior to fabrication.

the submittal of shop drawings.

- 2. Welds: All welds shall be ground smooth, paint all seams.
- 3. Hardware: All fasteners shall be concealed. If exposed, hardware shall be tamper proof fasteners, corrosion resistant, and color matching adjacent surfaces.
- 4. All painted sign surfaces to receive UV/Anti-Graffiti spray coating. All sign surfaces with reflective graphics to recieve 3M



D. Design Intent Drawings

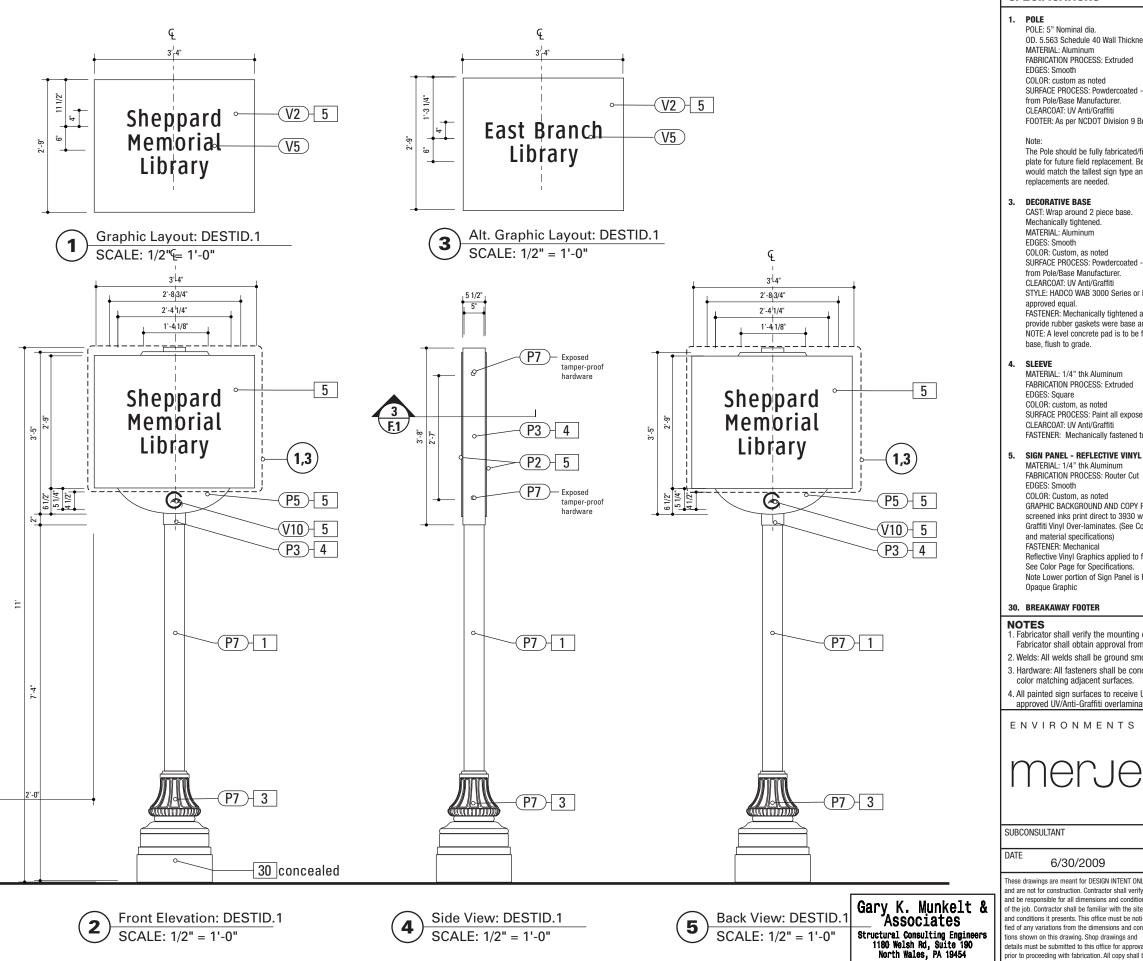

SPECIFICATIONS SIGN TYPE: DEST ID.1 FUNCTION: Arrival Sign

OD. 5.563 Schedule 40 Wall Thickness 0.258 ID 5.047 MATERIAL: Aluminum

COLOR: custom as noted

SURFACE PROCESS: Powdercoated - Finish: Factory Finish

CLEARCOAT: LIV Anti/Graffiti

FOOTER: As per NCDOT Division 9 Breakaway specifications

The Pole should be fully fabricated/finished with mounting plate for future field replacement. Bench Stock pole length would match the tallest sign type and trimmed to size as replacements are needed.

CAST: Wrap around 2 piece base. Mechanically tightened. MATERIAL: Aluminum COLOR: Custom, as noted SURFACE PROCESS: Powdercoated - Finish: Factory Finish

STYLE: HADCO WAB 3000 Series or HAPCO Brand ARLEN, or

FASTENER: Mechanically tightened around pole Contractor to provide rubber gaskets were base and pole meet for tight fit. NOTE: A level concrete pad is to be formed to anchor the

FABRICATION PROCESS: Extruded COLOR: custom, as noted SURFACE PROCESS: Paint all exposed surfaces CLEARCOAT: UV Anti/Graffiti FASTENER: Mechanically fastened to pole

FABRICATION PROCESS: Router Cut COLOR: Custom, as noted GRAPHIC BACKGROUND AND COPY PROCESS: 3M custom screened inks print direct to 3930 with 3M approved UV/ Graffiti Vinyl Over-laminates. (See Color Sheet A6 for all color and material specifications) FASTENER: Mechanical Reflective Vinyl Graphics applied to front face of Sign Panel. See Color Page for Specifications. Note Lower portion of Sign Panel is Painted with Applied

DESIGN NOTE:

Product: TRANSPO Breakaway sign support system or NCDOT

Size and specs to be determined by Contractors structural

NOTE: All signs are positioned within NCDOT R.O.W. and shall

be breakaway as per NCDOT Division 9 Breakaway specifica-

Seperate Spun Metal Base Cover hides couplings.

Finish: Factory Finish from Pole/Base Manufacturer.

A seperate Spun Metal Base Cover hides couplings and is

coordinated to fit around the Cast Metal Base to accom-

modate the Transpo Footer. (as shown in Bid Document

Providers of decorative bases (such as Hadco or Hapco)

provide the sized pole that matches the opening of the Base. Shop Drawings from the pole/base provider are required for

The design style suggested by the Contractor is subject to

Designer/Owner review and approval. Finish: Factory Finish

Approved equal Type: Male/Female Coupling assembly.

Base Plate welded to pole.

Drawings.)

review and approval.

from Pole/Base Manufacturer.

Final design and shop drawings shall be supplied by the fabricator. North Carolina registered professional engineer is required to sign and seal the submittal of shop drawings.


30. BREAKAWAY FOOTER


v legal department

Phone 215-855-8713 Fax 215-855-8714

- 1. Fabricator shall verify the mounting conditions and provide a detail drawing for each mounting situation, prior to fabrication. Fabricator shall obtain approval from the Designer or Client for placement prior to fabrication.
- 2. Welds: All welds shall be ground smooth, paint all seams.
- 3. Hardware: All fasteners shall be concealed. If exposed, hardware shall be tamper proof fasteners, corrosion resistant, and color matching adjacent surfaces.
- 4. All painted sign surfaces to receive UV/Anti-Graffiti spray coating. All sign surfaces with reflective graphics to recieve 3M

CLIENT / PROJECT ENVIRONMENTS & EXPERIENCES City of Greenville, NC 120 North Church Street City of Greenville, NC merje Suite 208 Wayfinding and Signage West Chester, PA 19380 T 484.266.0648 www.merjedesign.com PROJECT NO. Y41-07963 SHEET TITLE DRAWN BY: 6/30/2009 KB/GS Sign Type DEST_ID.1 These drawings are meant for DESIGN INTENT ONLY REVISIONS **Arrival Sign** and are not for construction. Contractor shall verify and be responsible for all dimensions and condition of the job. Contractor shall be familiar with the site 05/22/2010 and conditions it presents. This office must be noti-SHEET NO. fied of any variations from the dimensions and cond 08/06/2010 tions shown on this drawing. Shop drawings and details must be submitted to this office for approva **D.1** prior to proceeding with fabrication. All copy shall be 09/01/2010 proofread by client and legal requirements checked

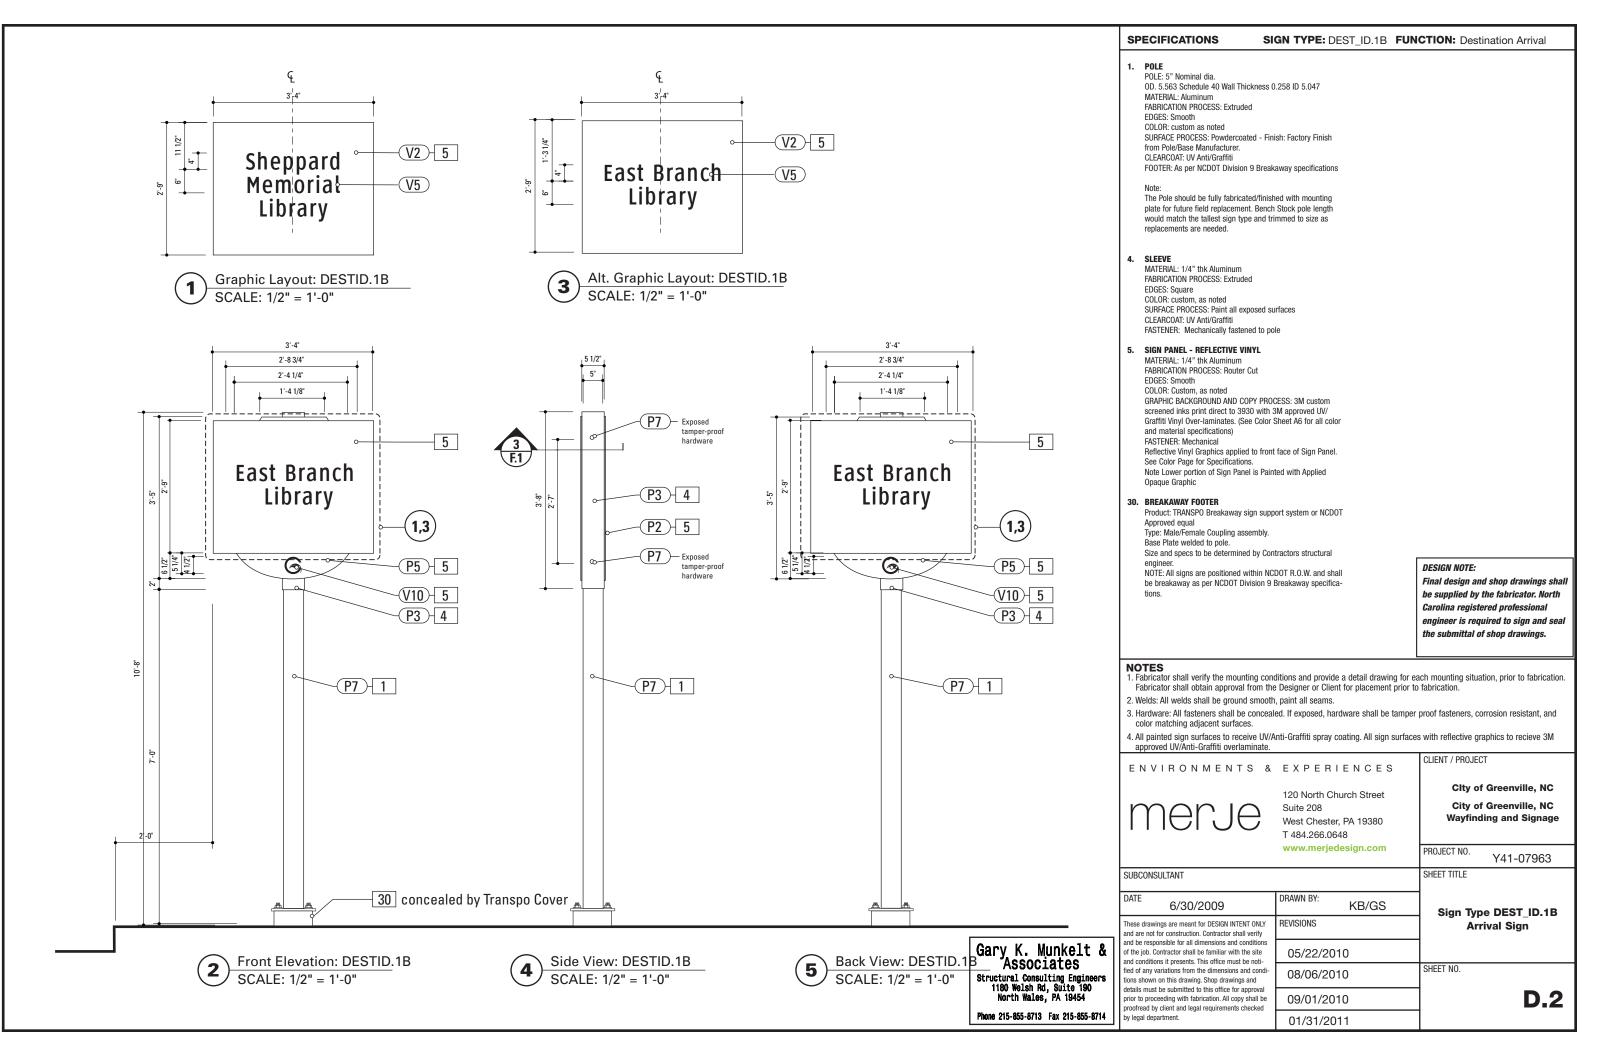

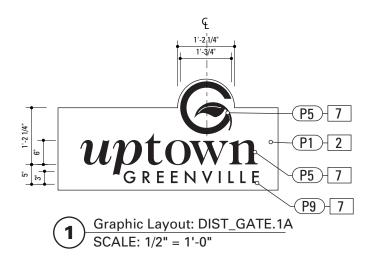

Front Elevation: DIST_GATE.1A

SCALE: 1/2" = 1'-0"

Examples shown are strictly for design intent color and look. All structural details, product type and construction details are the responsibility of the contractor. Product samples are to be provided to the designer/owner for review including sample of etched stone.


Brick: Mnf.-Acme Brick: Color/Style-Williamsburg Heritage or approved equal.

http://www.brick.com/cgi-bin/colorSelection.pl Stone: Mnf.-Cold Spring Granite – Color/Style -Champaign Mist or approved equal.

Finish: Diamond Ground

Graphic Sandblast Engraved Black Shadow. http://www.coldspringgranite.com/Stone-De-

tail/Kashmir-White.aspx

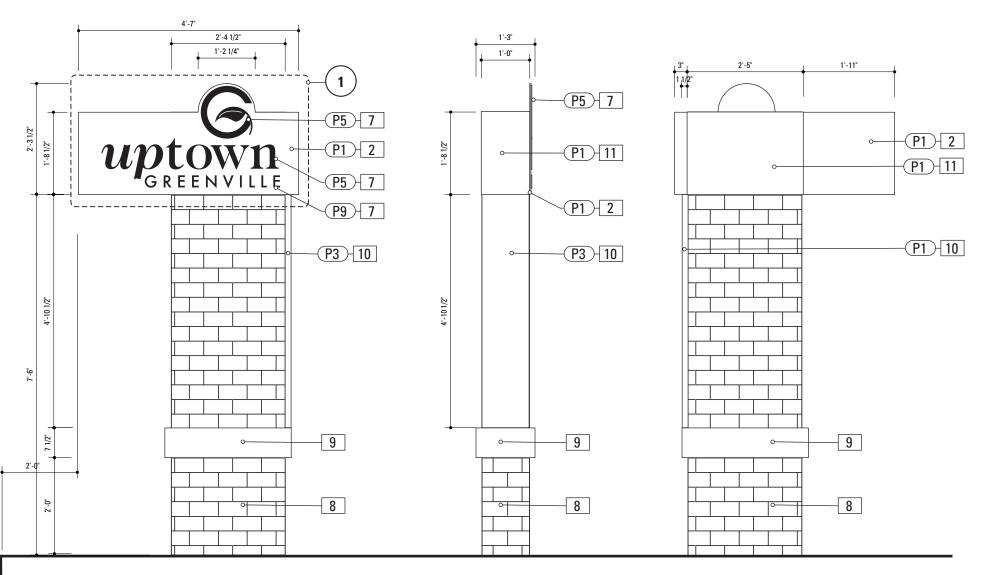

Side View: DIST_GATE.1A SCALE: 1/2" = 1'-0"

Back View: DIST_GATE.1A SCALE: 1/2" = 1'-0"

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SPECIFICATIONS

SIGN TYPE: DISTGATE.1A FUNCTION: District Gateway

SIGN PANEL

MATERIAL: 1/4" thk Aluminum FABRICATION PROCESS: Router Cut EDGES: Smooth COLOR: custom, as noted SURFACE PROCESS: Paint all exposed surfaces CLEARCOAT: UV Anti/Graffiti FASTENER: Mechanically fastened to sleeve

DIMENSIONAL GRAPHICS

MATERIAL · 1/4" thk Aluminum FABRICATION PROCESS: Water Jet or Router cut EDGES: Smooth COLOR: custom, as noted SURFACE PROCESS: Paint all exposed surfaces CLEARCOAT: UV Anti/Graffiti FASTENER: Chemical weld to sign panel

8. BRICK BASE
MATERIAL: Cinderblock base and brick to match uptown streetscape plan or approved equal FABRICATION PROCESS: Cinderblock base, cladded in brick CORNERS: Square COLOR: Match Master Plan Specification FOOTER: As per NCDOT Division 9 Breakaway specifications NOTE: A level concrete pad is to be formed to anchor the

9. STONE ACCENT

hase flush to grade

MATERIAL: Stone to match uptown streetscape plan or FABRICATION PROCESS: Match Master Plan Specification EDGES: Square CORNERS: Square COLOR: Match Master Plan Specification FASTENER: Match Master Plan Specification

10. ACCENT PANEL

MATERIAL: 1/2" thk Aluminum FABRICATION PROCESS: Square Cut EDGES: Square COLOR: custom as noted SURFACE PROCESS: Paint all exposed surfaces CLEARCOAT: UV Anti/Graffiti FASTENER: Mechanically fastened to brick base

11. BRACKET


MATERIAL: 1/4" thk Aluminum FABRICATION PROCESS: Extruded EDGES: Square COLOR: custom, as noted SURFACE PROCESS: Paint all exposed surfaces CLEARCOAT: UV Anti/Graffiti FASTENER: Mechanically fastened to brick base

DESIGN NOTE:

Final design and shop drawings shall be supplied by the fabricator. North Carolina registered professional engineer is required to sign and seal the submittal of shop drawings.

- 1. Fabricator shall verify the mounting conditions and provide a detail drawing for each mounting situation, prior to fabrication Fabricator shall obtain approval from the Designer or Client for placement prior to fabrication.
- 2. Welds: All welds shall be ground smooth, paint all seams.
- 3. Hardware: All fasteners shall be concealed. If exposed, hardware shall be tamper proof fasteners, corrosion resistant, and color matching adjacent surfaces.
- 4. All painted sign surfaces to receive UV/Anti-Graffiti spray coating. All sign surfaces with reflective graphics to recieve 3M



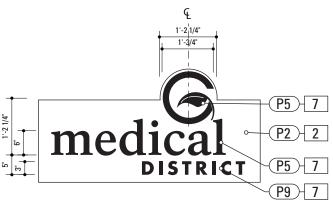

Alt. Graphic Layout: DIST_GATE.1B SCALE: 1/2" = 1'-0"


Examples shown are strictly for design intent color and look. All structural details, product type and construction details are the responsibility of the contractor. Product samples are to be provided to the designer/owner for review including sample of etched stone.

Brick: Mnf.-Acme Brick: Color/Style-Williamsburg Heritage or approved equal.

http://www.brick.com/cgi-bin/colorSelection.pl *Stone: Mnf.-Cold Spring Granite – Color/Style* -Champaign Mist or approved equal.

Finish: Diamond Ground

Graphic Sandblast Engraved Black Shadow. http://www.coldspringgranite.com/Stone-Detail/Kashmir-White.aspx

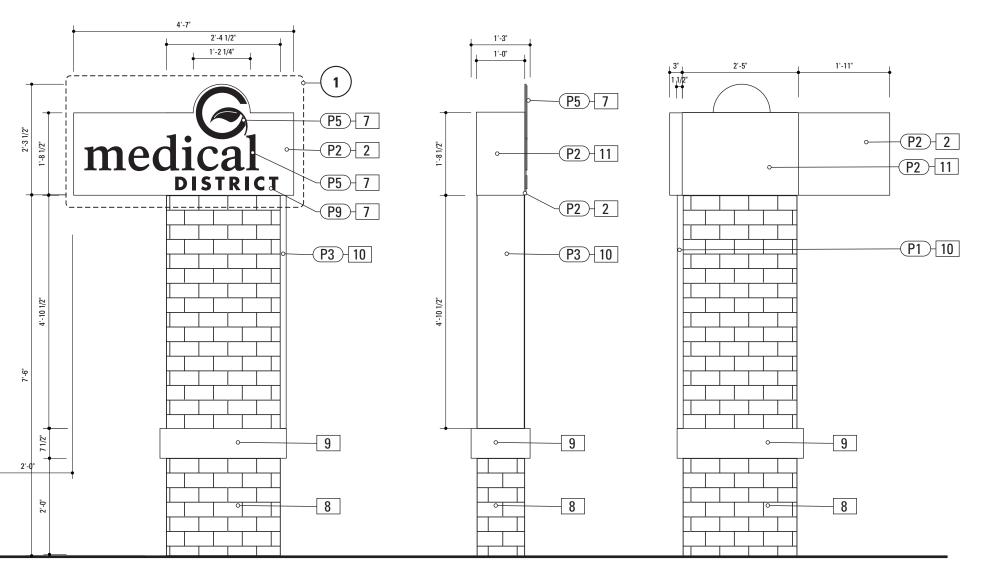

Front Elevation: DIST_GATE.1B

SCALE: 1/2" = 1'-0"

Side View: DIST_GATE.1B SCALE: 1/2" = 1'-0"

Back View: DIST_GATE.1B SCALE: 1/2" = 1'-0"

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SPECIFICATIONS

SIGN TYPE: DISTGATE.1B FUNCTION: District Gateway

SIGN PANEL

MATERIAL: 1/4" thk Aluminum FABRICATION PROCESS: Router Cut EDGES: Smooth COLOR: custom, as noted SURFACE PROCESS: Paint all exposed surfaces CLEARCOAT: UV Anti/Graffiti FASTENER: Mechanically fastened to sleeve

DIMENSIONAL GRAPHICS

MATERIAL · 1/4" thk Aluminum FABRICATION PROCESS: Water Jet or Router cut EDGES: Smooth COLOR: custom, as noted SURFACE PROCESS: Paint all exposed surfaces CLEARCOAT: UV Anti/Graffiti FASTENER: Chemical weld to sign panel

8. BRICK BASE

MATERIAL: Cinderblock base and brick to match uptown streetscape plan or approved equal FABRICATION PROCESS: Cinderblock base, cladded in brick CORNERS: Square COLOR: Match Master Plan Specification FOOTER: As per NCDOT Division 9 Breakaway specifications NOTE: A level concrete pad is to be formed to anchor the hase flush to grade

9. STONE ACCENT

MATERIAL: Stone to match uptown streetscape plan or FABRICATION PROCESS: Match Master Plan Specification EDGES: Square CORNERS: Square COLOR: Match Master Plan Specification FASTENER: Match Master Plan Specification

10. ACCENT PANEL

MATERIAL: 1/2" thk Aluminum FABRICATION PROCESS: Square Cut EDGES: Square COLOR: custom as noted SURFACE PROCESS: Paint all exposed surfaces CLEARCOAT: UV Anti/Graffiti FASTENER: Mechanically fastened to brick base

11. BRACKET


MATERIAL: 1/4" thk Aluminum FABRICATION PROCESS: Extruded EDGES: Square COLOR: custom, as noted SURFACE PROCESS: Paint all exposed surfaces CLEARCOAT: UV Anti/Graffiti FASTENER: Mechanically fastened to brick base

DESIGN NOTE:

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- 1. Fabricator shall verify the mounting conditions and provide a detail drawing for each mounting situation, prior to fabrication. Fabricator shall obtain approval from the Designer or Client for placement prior to fabrication.
- 2. Welds: All welds shall be ground smooth, paint all seams.
- 3. Hardware: All fasteners shall be concealed. If exposed, hardware shall be tamper proof fasteners, corrosion resistant, and color matching adjacent surfaces.
- 4. All painted sign surfaces to receive UV/Anti-Graffiti spray coating. All sign surfaces with reflective graphics to recieve 3M



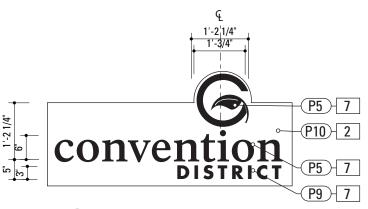

Graphic Layout: DIST_GATE.1C

SCALE: 1/2" = 1'-0"

Examples shown are strictly for design intentcolor and look. All structural details, product type and construction details are the responsibility of the contractor. Product samples are to be provided to the designer/owner for review including sample of etched stone.


Brick: Mnf.-Acme Brick: Color/Style-Williamsburg Heritage or approved equal.

http://www.brick.com/cgi-bin/colorSelection.pl Stone: Mnf.-Cold Spring Granite – Color/Style -Champaign Mist or approved equal.

-Champaign Mist or approved ed Finish: Diamond Ground

Graphic Sandblast Engraved Black Shadow. http://www.coldspringgranite.com/Stone-De-

tail/Kashmir-White.aspx

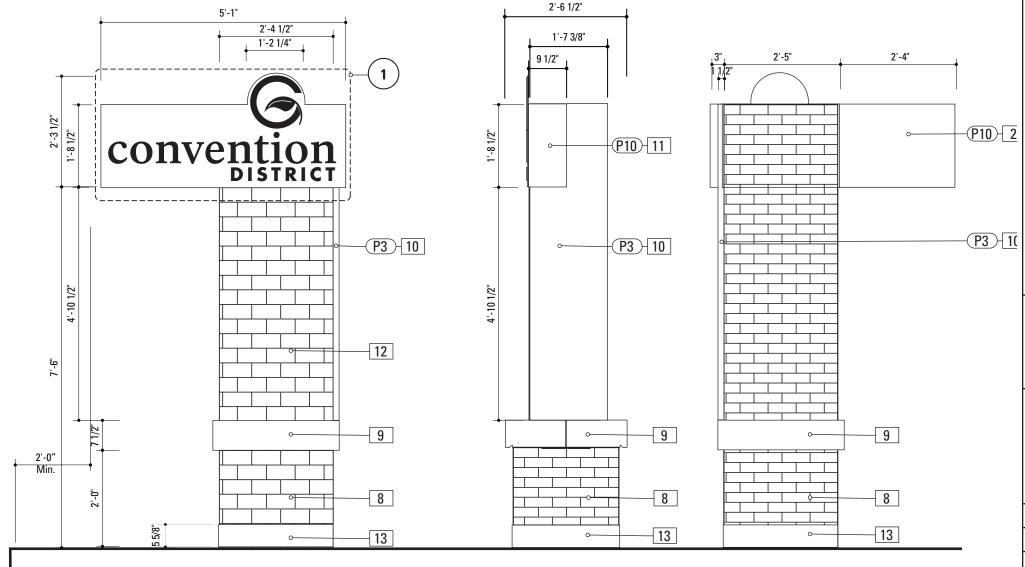

Front Elevation: DIST_GATE.1C

SCALE: 1/2" = 1'-0"

Side View: DIST_GATE.1C SCALE: 1/2" = 1'-0"

(4)-

Back View: DIST_GATE: 16ary K. Munkelt & SCALE: 1/2" = 1'-0"
ASSOCIATES

Gary K. Munkelt & Associates
Structural Consulting Engineers
1180 Welsh Rd, Suite 190
North Wales, PA 18454
Phone 215-855-8713 Fax 215-855-8714

SPECIFICATIONS

SIGN TYPE: DISTGATE.2C FUNCTION: District Gateway

2. SIGN PANEL

MATERIAL: 1/4" thk Aluminum
FABRICATION PROCESS: Router Cut
EDGES: Smooth
COLOR: custom, as noted
SURFACE PROCESS: Paint all exposed surfaces
CLEARCOAT: UV Anti/Graffiti
FASTENER: Mechanically fastened to sleeve

7. DIMENSIONAL GRAPHICS

MATERIAL: 1/4" thik Aluminum
FABRICATION PROCESS: Water Jet or Router cut
EDGES: Smooth
COLOR: custom, as noted
SURFACE PROCESS: Paint all exposed surfaces
CLEARCOAT: UV Anti/Graffiti
FASTENER: Chemical weld to sign panel

8. BRICK BASE

MATERIAL: Cinderblock base and brick to match uptown streetscape plan or approved equal FABRICATION PROCESS: Cinderblock base, cladded in brick EDGES: Square CORNERS: Square COLOR: Match Master Plan Specification FOOTER: As per NCDOT Division 9 Breakaway specifications NOTE: A level concrete pad is to be formed to anchor the

9. STONE ACCENT

hase flush to grade

MATERIAL: Stone to match uptown streetscape plan or approved equal FABRICATION PROCESS: Match Master Plan Specification EDGES: Square CORNERS: Square CORNERS: Square FASTENER: Match Master Plan Specification FASTENER: Match Master Plan Specification

10. ACCENT PANEL

MATERIAL: 1/2" thk Aluminum
FABRICATION PROCESS: Square Cut
EDGES: Square
COLOR: custom, as noted
SURFACE PROCESS: Paint all exposed surfaces
CLEARCOAT: UV Anti/Graffiti
FASTENER: Mechanically fastened to brick base

11. BRACKET

MATERIAL: 1/4" thk Aluminum
FABRICATION PROCESS: Extruded
EDGES: Square
COLOR: custom, as noted
SURFACE PROCESS: Paint all exposed surfaces
CLEARCOAT: UV Anti/Graffiti
ACTENIER: Machanically factored to brick base


DESIGN NOTE:

Final design and shop drawings shall be supplied by the fabricator. North Carolina registered professional engineer is required to sign and seal the submittal of shop drawings.

IOTES


- Fabricator shall verify the mounting conditions and provide a detail drawing for each mounting situation, prior to fabrication
 Fabricator shall obtain approval from the Designer or Client for placement prior to fabrication.
- 2. Welds: All welds shall be ground smooth, paint all seams.
- Hardware: All fasteners shall be concealed. If exposed, hardware shall be tamper proof fasteners, corrosion resistant, and color matching adjacent surfaces.
- 4. All painted sign surfaces to receive UV/Anti-Graffiti spray coating. All sign surfaces with reflective graphics to recieve 3M



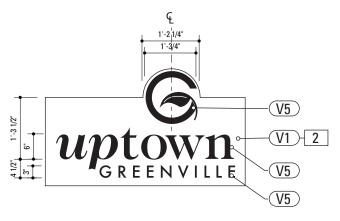

Graphic Layout: DIST_GATE.2A

SCALE: 1/2" = 1'-0"

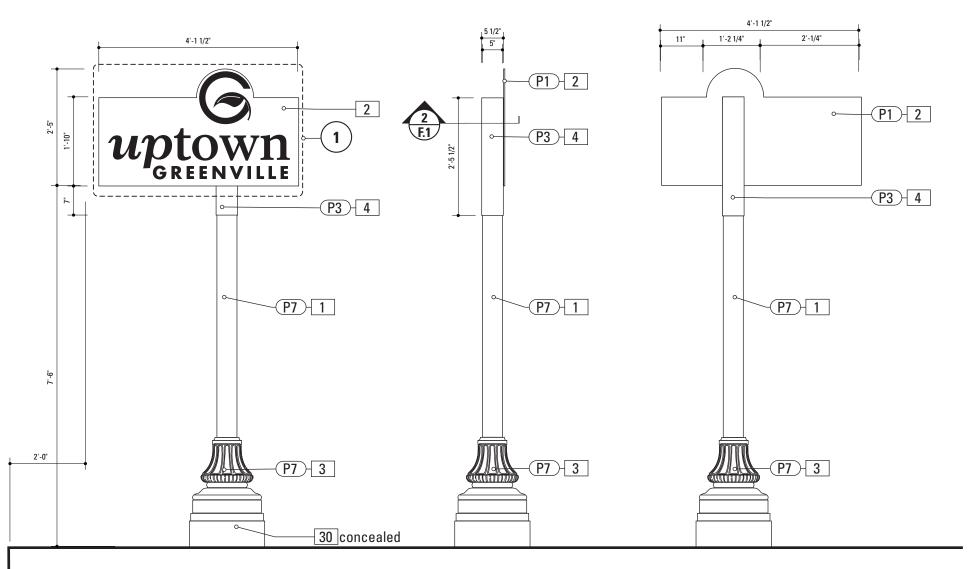

Front Elevation: DIST_GATE.2A
SCALE: 1/2" = 1'-0"

Side View: DIST_GATE.2A
SCALE: 1/2" = 1'-0"

Back View: DIST_GATE.2A

SCALE: 1/2" = 1'-0"

Gary K. Munkelt & Associates
Structural Consulting Engineers
1180 Welsh Rd, Suite 190
North Wales, PA 19454

Phone 215-855-8713 Fax 215-855-8714 by legal department.

SPECIFICATIONS

SIGN TYPE: DISTGATE.2A **FUNCTION:** District Gateway

1. PO

POLE: 5" Nominal dia. OD. 5.563 Schedule 40 Wall Thickness 0.258 ID 5.047 MATERIAL: Aluminum

FABRICATION PROCESS: Extruded

EDGES: Smooth

COLOR: custom as noted

SURFACE PROCESS: Powdercoated - Finish: Factory Finish

from Pole/Base Manufacturer. CLEARCOAT: UV Anti/Graffiti

FOOTER: As per NCDOT Division 9 Breakaway specifications

Note

The Pole should be fully fabricated/finished with mounting plate for future field replacement. Bench Stock pole length would match the tallest sign type and trimmed to size as replacements are needed.

2. SIGN PANEL - REFLECTIVE VINYL

MATERIAL: 1/4" thk Aluminum FABRICATION PROCESS: Router Cut

EDGES: Smooth

COLOR: Custom, as noted

GRAPHIC BACKGROUND AND COPY PROCESS: 3M custom screened inks print direct to 3930 with 3M approved UV/ Graffiti Vinyl Over-laminates. (See Color Sheet A6 for all color and material specifications)

FASTENER: Mechanical

Reflective Vinyl Graphics applied to front face of Sign Panel. See Color Page for Specifications.

3. DECORATIVE BASE

CAST: Wrap around 2 piece base.

Mechanically tightened.
MATERIAL: Aluminum

EDGES: Smooth

COLOR: Custom, as noted SURFACE PROCESS: Powdercoated - Finish: Factory Finish

from Pole/Base Manufacturer.

CLEARCOAT: UV Anti/Graffiti

STYLE: HADCO WAB 3000 Series or HAPCO Brand ARLEN. or approved equal.

FASTENER: Mechanically tightened around pole Contractor to provide rubber gaskets were base and pole meet for tight fit.

NOTE: A level concrete pad is to be formed to anchor the base, flush to grade.

4 SI FEVE

MATERIAL: 1/4" thk Aluminum FABRICATION PROCESS: Extruded EDGES: Square

COLOR: custom, as noted SURFACE PROCESS: Paint all exposed surfaces

CLEARCOAT: UV Anti/Graffiti
FASTENER: Mechanically fastened to pole

30. BREAKAWAY FOOTER

Product: TRANSPO Breakaway sign support system or NCDOT Approved equal

Type: Male/Female Coupling assembly.

Base Plate welded to pole.

Size and specs to be determined by Contractors structural engineer.

NOTE: All signs are positioned within NCDOT R.O.W. and shall be breakaway as per NCDOT Division 9 Breakaway specifica-

Seperate Spun Metal Base Cover hides couplings.

Finish: Factory Finish from Pole/Base Manufacturer.

NOTE:

A seperate Spun Metal Base Cover hides couplings and is coordinated to fit around the Cast Metal Base to accommodate the Transpo Footer. (as shown in Bid Document Drawings.)

Providers of decorative bases (such as Hadco or Hapco) provide the sized pole that matches the opening of the Base. Shop Drawings from the pole/base provider are required for review and approval.

The design style suggested by the Contractor is subject to Designer/Owner review and approval. Finish: Factory Finish from Pole/Base Manufacturer.


DESIGN NOTE:

Final design and shop drawings shall be supplied by the fabricator. North Carolina registered professional engineer is required to sign and seal the submittal of shop drawings.


NOTES

- Fabricator shall verify the mounting conditions and provide a detail drawing for each mounting situation, prior to fabrication.
 Fabricator shall obtain approval from the Designer or Client for placement prior to fabrication.
- 2. Welds: All welds shall be ground smooth, paint all seams.
- Hardware: All fasteners shall be concealed. If exposed, hardware shall be tamper proof fasteners, corrosion resistant, and color matching adjacent surfaces.
- 4. All painted sign surfaces to receive UV/Anti-Graffiti spray coating. All sign surfaces with reflective graphics to recieve 3M



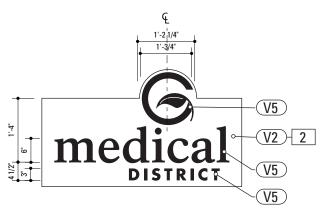

Alt. Graphic Layout: DIST_GATE.2B SCALE: 1/2" = 1'-0"

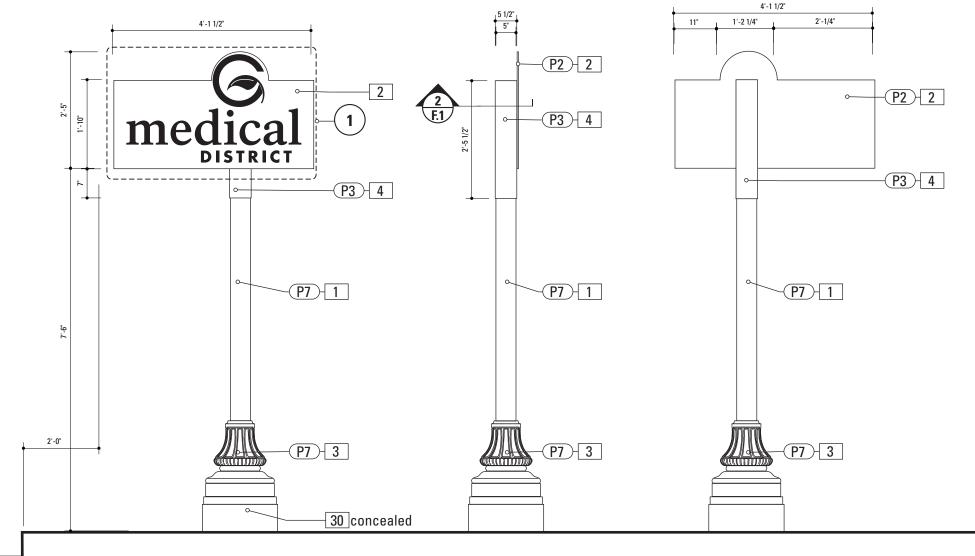

Front Elevation: DIST_GATE.2B SCALE: 1/2" = 1'-0"

Side View: DIST_GATE.2B SCALE: 1/2" = 1'-0"

Back View: DIST_GATE.2B SCALE: 1/2" = 1'-0"

Gary K. Munkelt & Associates Structural Consulting Engineers 1180 Welsh Rd, Suite 190 North Wales, PA 19454

Phone 215-855-8713 Fax 215-855-8714 y legal department.

SPECIFICATIONS

SIGN TYPE: DISTGATE.2B FUNCTION: District Gateway

POLE: 5" Nominal dia. OD. 5.563 Schedule 40 Wall Thickness 0.258 ID 5.047 MATERIAI · Aluminum

FABRICATION PROCESS: Extruded

EDGES: Smooth

COLOR: custom as noted SURFACE PROCESS: Powdercoated - Finish: Factory Finish

from Pole/Base Manufacturer. CLEARCOAT: UV Anti/Graffiti

FOOTER: As per NCDOT Division 9 Breakaway specifications

The Pole should be fully fabricated/finished with mounting plate for future field replacement. Bench Stock pole length would match the tallest sign type and trimmed to size as replacements are needed.

2. SIGN PANEL - REFLECTIVE VINYL

MATERIAL: 1/4" thk Alumi FABRICATION PROCESS: Router Cut

EDGES: Smooth

COLOR: Custom, as noted

GRAPHIC BACKGROUND AND COPY PROCESS: 3M custom screened inks print direct to 3930 with 3M approved UV/ Graffiti Vinyl Over-laminates. (See Color Sheet A6 for all color and material specifications)

FASTENER: Mechanical

Reflective Vinyl Graphics applied to front face of Sign Panel. See Color Page for Specifications.

DECORATIVE BASE

CAST: Wrap around 2 piece base.

Mechanically tightened. MATERIAL: Aluminum

FDGFS: Smooth

COLOR: Custom, as noted SURFACE PROCESS: Powdercoated - Finish: Factory Finish

from Pole/Base Manufacturer.

CLEARCOAT: UV Anti/Graffiti STYLE: HADCO WAB 3000 Series or HAPCO Brand ARLEN. or

base, flush to grade,

approved equal. FASTENER: Mechanically tightened around pole Contractor to provide rubber gaskets were base and pole meet for tight fit. NOTE: A level concrete pad is to be formed to anchor the

MATERIAL: 1/4" thk Aluminum FABRICATION PROCESS: Extruded EDGES: Square

COLOR: custom, as noted SURFACE PROCESS: Paint all exposed surfaces CLEARCOAT: UV Anti/Graffiti

FASTENER: Mechanically fastened to pole

30. BREAKAWAY FOOTER

Product: TRANSPO Breakaway sign support system or NCDOT Approved equal

Type: Male/Female Coupling assembly.

Base Plate welded to pole.

Size and specs to be determined by Contractors structural engineer.

NOTE: All signs are positioned within NCDOT R.O.W. and shall be breakaway as per NCDOT Division 9 Breakaway specifica-

Seperate Spun Metal Base Cover hides couplings.

Finish: Factory Finish from Pole/Base Manufacturer

NOTE:

A seperate Spun Metal Base Cover hides couplings and is coordinated to fit around the Cast Metal Base to accommodate the Transpo Footer. (as shown in Bid Document Drawings.)

Providers of decorative bases (such as Hadco or Hapco) provide the sized pole that matches the opening of the Base. Shop Drawings from the pole/base provider are required for review and approval.


The design style suggested by the Contractor is subject to Designer/Owner review and approval. Finish: Factory Finish from Pole/Base Manufacturer.

DESIGN NOTE:


Final design and shop drawings shall be supplied by the fabricator. North Carolina registered professional engineer is required to sign and seal the submittal of shop drawings.

- 1. Fabricator shall verify the mounting conditions and provide a detail drawing for each mounting situation, prior to fabrication. Fabricator shall obtain approval from the Designer or Client for placement prior to fabrication.
- 2. Welds: All welds shall be ground smooth, paint all seams.
- 3. Hardware: All fasteners shall be concealed. If exposed, hardware shall be tamper proof fasteners, corrosion resistant, and color matching adjacent surfaces.
- 4. All painted sign surfaces to receive UV/Anti-Graffiti spray coating. All sign surfaces with reflective graphics to recieve 3M



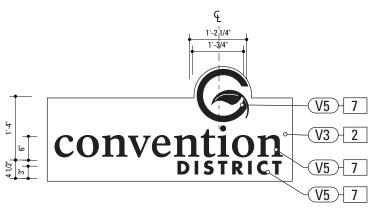

Alt. Graphic Layout: DIST_GATE.2C SCALE: 1/2" = 1'-0"

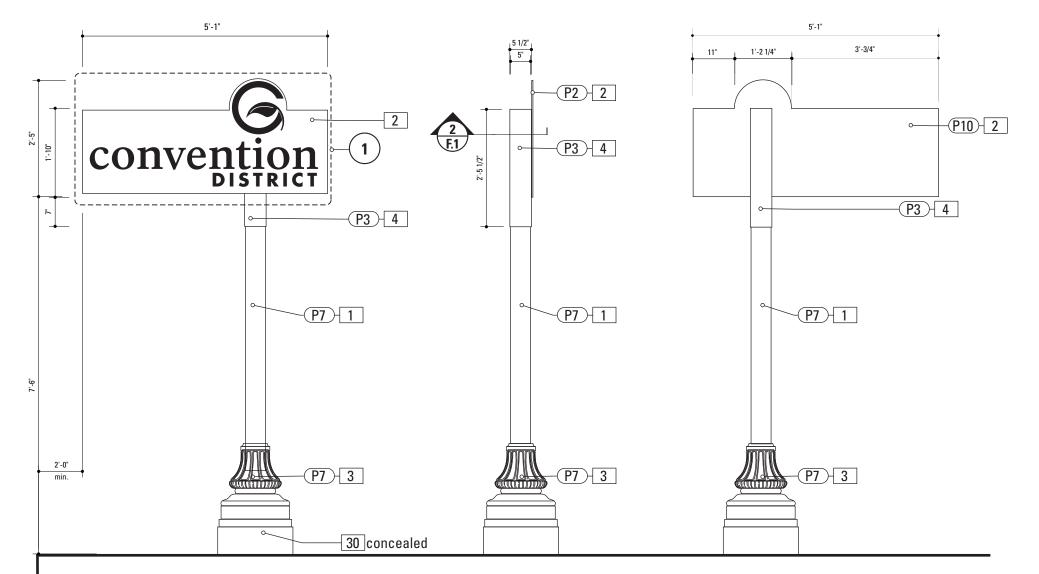

Front Elevation: DIST_GATE.2C
SCALE: 1/2" = 1'-0"

Side View: DIST_GATE.2C

SCALE: 1/2" = 1'-0"

Back View: DIST_GATE.2C
SCALE: 1/2" = 1'-0"

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Structural Consulting Engineers
1180 Welsh Rd, Suite 190
North Wales, PA 19454

Phone 215-855-8713 Fax 215-855-8714 by le

SPECIFICATIONS

SIGN TYPE:DISTGATE.2C FUNCTION: District Gateway

1. PO

POLE: 5" Nominal dia.

OD. 5.563 Schedule 40 Wall Thickness 0.258 ID 5.047
MATERIAL: Aluminum

FABRICATION PROCESS: Extruded

EDGES: Smooth COLOR: custom as noted

SURFACE PROCESS: Powdercoated - Finish: Factory Finish

from Pole/Base Manufacturer. CLEARCOAT: UV Anti/Graffiti

FOOTER: As per NCDOT Division 9 Breakaway specifications

Note

The Pole should be fully fabricated/finished with mounting plate for future field replacement. Bench Stock pole length would match the tallest sign type and trimmed to size as replacements are needed.

2. SIGN PANEL - REFLECTIVE VINYL MATERIAL: 1/4" thk Aluminum

MATERIAL: 1/4" thk Aluminum FABRICATION PROCESS: Router Cut

EDGES: Smooth

COLOR: Custom, as noted

GRAPHIC BACKGROUND AND COPY PROCESS: 3M custom screened inks print direct to 3930 with 3M approved UV/ Graffiti Vinyl Over-laminates. (See Color Sheet A6 for all color and material specifications)
FASTENER: Mechanical

Reflective Vinyl Graphics applied to front face of Sign Panel.

See Color Page for Specifications.

3. DECORATIVE BASE

CAST: Wrap around 2 piece base.

Mechanically tightened.
MATERIAL: Aluminum

EDGES: Smooth

COLOR: Custom, as noted

SURFACE PROCESS: Powdercoated - Finish: Factory Finish from Pole/Base Manufacturer.

CLEARCOAT: UV Anti/Graffiti

STYLE: HADCO WAB 3000 Series or HAPCO Brand ARLEN. or

approved equal.
FASTENER: Mechanically tightened around pole Contractor to

provide rubber gaskets were base and pole meet for tight fit. NOTE: A level concrete pad is to be formed to anchor the base, flush to grade.

4. SLEEVE

MATERIAL: 1/4" thk Aluminum
FABRICATION PROCESS: Extruded
EDGES: Square
COLOR: custom, as noted
SUBFACE PROCESS: Paint all exposed su

SURFACE PROCESS: Paint all exposed surfaces
CLEARCOAT: UV Anti/Graffiti
FASTENER: Mechanically fastened to pole

30. BREAKAWAY FOOTER

Product: TRANSPO Breakaway sign support system or NCDOT Approved equal

Type: Male/Female Coupling assembly.

Base Plate welded to pole.

Size and specs to be determined by Contractors structural engineer.

NOTE: All signs are positioned within NCDOT R.O.W. and shall be breakaway as per NCDOT Division 9 Breakaway specifica-

Seperate Spun Metal Base Cover hides couplings.

Finish: Factory Finish from Pole/Base Manufacturer.

NOTE:

A seperate Spun Metal Base Cover hides couplings and is coordinated to fit around the Cast Metal Base to accommodate the Transpo Footer. (as shown in Bid Document Drawings.)

Providers of decorative bases (such as Hadco or Hapco) provide the sized pole that matches the opening of the Base. Shop Drawings from the pole/base provider are required for review and approval.

The design style suggested by the Contractor is subject to Designer/Owner review and approval. Finish: Factory Finish from Pole/Base Manufacturer.


DESIGN NOTE:

Final design and shop drawings shall be supplied by the fabricator. North Carolina registered professional engineer is required to sign and seal the submittal of shop drawings.

NOTES

- Fabricator shall verify the mounting conditions and provide a detail drawing for each mounting situation, prior to fabrication.
 Fabricator shall obtain approval from the Designer or Client for placement prior to fabrication.
- 2. Welds: All welds shall be ground smooth, paint all seams.
- 3. Hardware: All fasteners shall be concealed. If exposed, hardware shall be tamper proof fasteners, corrosion resistant, and color matching adjacent surfaces.
- 4. All painted sign surfaces to receive UV/Anti-Graffiti spray coating. All sign surfaces with reflective graphics to receive 3M



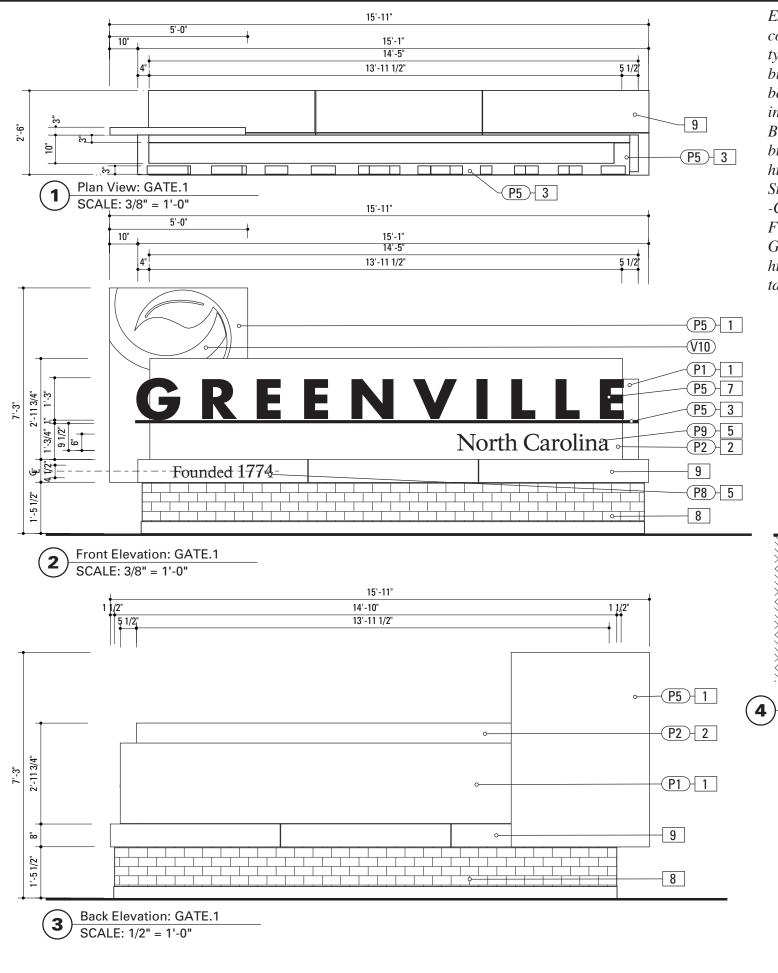


Examples shown are strictly for design intent color and look. All structural details, product type and construction details are the responsibility of the contractor. Product samples are to be provided to the designer/owner for review including sample of etched stone.

Brick: Mnf.-Acme Brick: Color/Style-Williamsburg Heritage or approved equal.

http://www.brick.com/cgi-bin/colorSelection.pl Stone: Mnf.-Cold Spring Granite – Color/Style -Champaign Mist or approved equal.

Finish: Diamond Ground

Graphic Sandblast Engraved Black Shadow. http://www.coldspringgranite.com/Stone-Detail/Kashmir-White.aspx

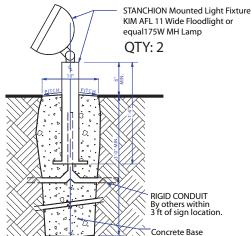

External Light Fixture: GATE.1 SCALE: NTS

Structural Consulting Engineers 1180 Welsh Rd, Suite 190 North Wales, PA 19454

Phone 215-855-8713 Fax 215-855-8714

SPECIFICATIONS

SIGN CABINET

MATERIAL: Aluminum Fascia thickness - as required STRUCTURE: Aluminum Extrusion Framing - as required FARRICATION PROCESS: Cut / Welded EDGES: Square

SIGN TYPE: GATE.1

COLOR: custom, as noted SURFACE PROCESS: Paint all exposed surfaces CLEARCOAT: UV Anti/Graffiti

SIGN PANEL

MATERIAL: 1/4" thk Aluminum FABRICATION PROCESS: Router Cut FDGFS: Smooth COLOR: custom, as noted SURFACE PROCESS: Paint all exposed surfaces CLEARCOAT: UV Anti/Graffiti FASTENER: Mechanically fastened to sleeve

DIMENSIONAL GRAPHICS

MATERIAL · 1/4" thk Aluminuu FABRICATION PROCESS: Water Jet or Router cut EDGES: Smooth COLOR: custom, as noted SURFACE PROCESS: Paint all exposed surfaces CLEARCOAT: UV Anti/Graffiti FASTENER: Chemical weld to sign panel

DIMENSIONAL GRAPHICS

MATERIAL: 3" Thick Dimensional Letters FABRICATION PROCESS: Fabricated/Cut /Welded EDGES: Smooth COLOR: custom, as noted SURFACE PROCESS: Paint all exposed surfaces CLEARCOAT: UV Anti/Graffiti FASTENER: Mechanical

8. BRICK BASE

MATERIAL: Cinderblock base and brick to match uptown streetscape plan or approved equal FABRICATION PROCESS: Cinderblock base, cladded in brick EDGES: Square CORNERS: Square COLOR: Match Master Plan Specification FOOTER: As per NCDOT Division 9 Breakaway specifications NOTE: A level concrete pad is to be formed to anchor the base, flush to grade

MATERIAL: Stone to match uptown streetscape plan or FABRICATION PROCESS: Match Master Plan Specification EDGES: Square CORNERS: Square COLOR: Match Master Plan Specification FASTENER: Match Master Plan Specification

PRODUCT: As shown or approved equal

FUNCTION: City Gateway

PLACEMENT: In Field as per Owner/Architect specification

as to NOT obscure sign and provide even and adequate illu-

QUANTITY: 2


Final design and shop drawings shall be supplied by the fabricator. North Carolina registered professional engineer is required to sign and seal the submittal of shop drawings.


- 1. Fabricator shall verify the mounting conditions and provide a detail drawing for each mounting situation, prior to fabrication Fabricator shall obtain approval from the Designer or Client for placement prior to fabrication.
- 2. Welds: All welds shall be ground smooth, paint all seams.
- 3. Hardware: All fasteners shall be concealed. If exposed, hardware shall be tamper proof fasteners, corrosion resistant, and color matching adjacent surfaces.
- 4. All painted sign surfaces to receive UV/Anti-Graffiti spray coating. All sign surfaces with reflective graphics to recieve 3M



01/31/2011

Gary K. Munkelt & Associates

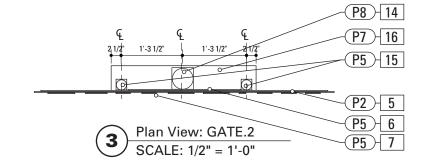

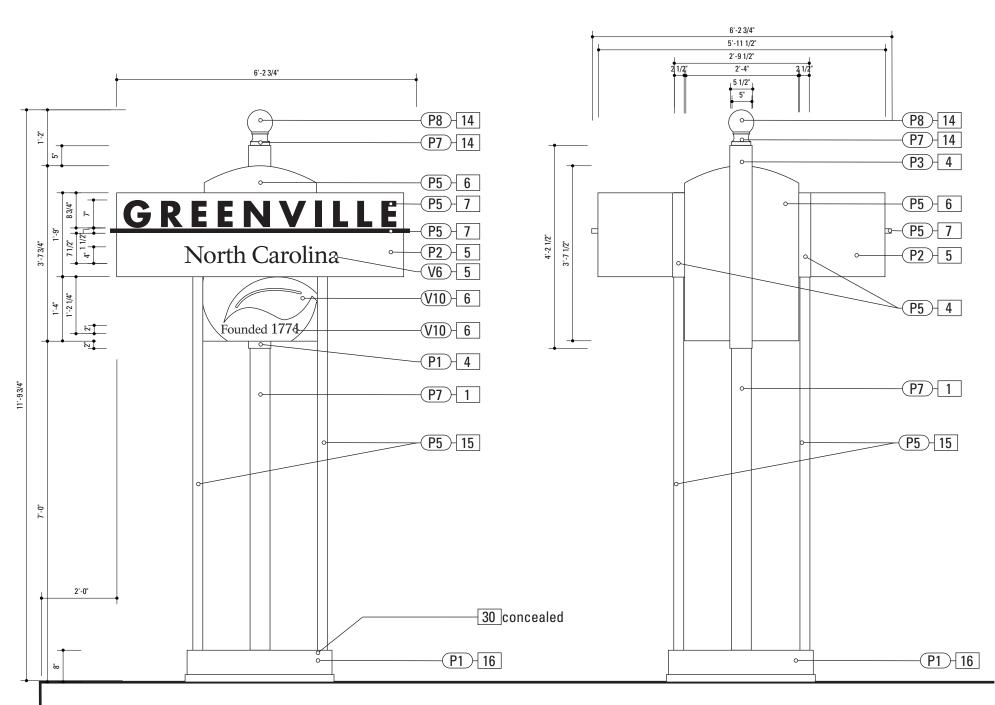

Front Elevation: GATE.2 SCALE: 1/2" = 1'-0"

Back View: GATE.2 SCALE: 1/2" = 1'-0"

Gary K. Munkelt & Associates Structural Consulting Engineers 1180 Welsh Rd, Suite 190 North Wales, PA 19454

Phone 215-855-8713 Fax 215-855-8714

SPECIFICATIONS

POLE: 5" dia. 1/4" thick aluminum MATERIAL: Aluminum FABRICATION PROCESS: Extruded EDGES: Smooth

COLOR: custom as noted SURFACE PROCESS: Paint all exposed surfaces CLEARCOAT: UV Anti/Graffiti

FOOTER: As per NCDOT Division 9 Breakaway specifications

SIGN TYPE: GATE.2

The Pole should be fully fabricated/finished with mounting plate for future field replacement. Bench Stock pole length would match the tallest sign type and trimmed to size as replacements are needed.

BREAKAWAY FOOTER

Male/Female Coupling assembly Base Plate welded to pole. Size and specs to be determined by Contractors structural engineer. As per NCDOT Division 9 Breakaway specifica-

SLEEVE

MATERIAL: 1/4" thk Aluminum FABRICATION PROCESS: Extruded EDGES: Square COLOR: custom, as noted SURFACE PROCESS: Paint all exposed surfaces CLEARCOAT: UV Anti/Graffiti FASTENER: Mechanically fastened to pole

5. SIGN PANEL

MATERIAL: 1/4" thk Aluminum FABRICATION PROCESS: Square Cut FDGFS: Square COLOR: custom, as noted SURFACE PROCESS: Paint all exposed surfaces CLEARCOAT: UV Anti/Graffiti FASTENER: Mechanically fastened to backer panel

6. BACKER PANEL

MATERIAL: 1/4" thk Aluminum FABRICATION PROCESS: Router Cut EDGES: Smooth COLOR: custom, as noted SURFACE PROCESS: Paint all exposed surfaces CLEARCOAT: UV Anti/Graffiti FASTENER: Mechanically fastened to sleeve

7. DIMENSIONAL GRAPHICS

CLEARCOAT: UV Anti/Graffiti

MATERIAL · 1/4" thk Aluminum FABRICATION PROCESS: Water Jet or Router cut EDGES: Smooth COLOR: custom, as noted SURFACE PROCESS: Paint all exposed surfaces

Final design and shop drawings shall

NOTES

- 1. Fabricator shall verify the mounting conditions and provide a detail drawing for each mounting situation, prior to fabrication. Fabricator shall obtain approval from the Designer or Client for placement prior to fabrication.
- 2. Welds: All welds shall be ground smooth, paint all seams.
- 3. Hardware: All fasteners shall be concealed. If exposed, hardware shall be tamper proof fasteners, corrosion resistant, and color matching adjacent surfaces.
- 4. All painted sign surfaces to receive UV/Anti-Graffiti spray coating. All sign surfaces with reflective graphics to recieve 3M



SURFACE PROCESS: Paint all exposed surfaces CLEARCOAT: UV Anti/Graffiti FASTENER: Mechanically fasten to pole

FASTENER: Chemical weld to sign panel

PRODUCT: Cast Aluminum Post Top Finial

FUNCTION: City Gateway

15. ACCENT POLE POLE: 2 1/2" dia. 1/4" thick aluminum

14. POLE CAP

MATERIAL: Aluminum

EDGES: Smooth

FABRICATION PROCESS: Cast

COLOR: custom as noted

MATERIAL: Aluminum FABRICATION PROCESS: Extruded EDGES: Smooth COLOR: custom as noted SURFACE PROCESS: Paint all exposed surfaces CLEARCOAT: UV Anti/Graffiti FOOTER: Mechanically fastened to base

16. BASE

MATERIAL: 1/4" thk Aluminum FABRICATION PROCESS: Fabricated SIZE: as required to cover Breakaway FOOTER Assembly EDGES: Square COLOR: custom, as noted SURFACE PROCESS: Paint all exposed surfaces CLEARCOAT: UV Anti/Graffiti FASTENER: Mechanically fastened to poles NOTE: A level concrete pad is to be formed to anchor the

30. BREAKAWAY FOOTER

base, flush to grade.

Product: TRANSPO Breakaway sign support system or NCDOT Approved equal Type: Male/Female Coupling assembly.


Base Plate welded to pole.

Size and specs to be determined by Contractors structural

NOTE: All signs are positioned within NCDOT R.O.W. and shall be breakaway as per NCDOT Division 9 Breakaway specifica-

DESIGN NOTE:

be supplied by the fabricator. North Carolina registered professional engineer is required to sign and seal the submittal of shop drawings.

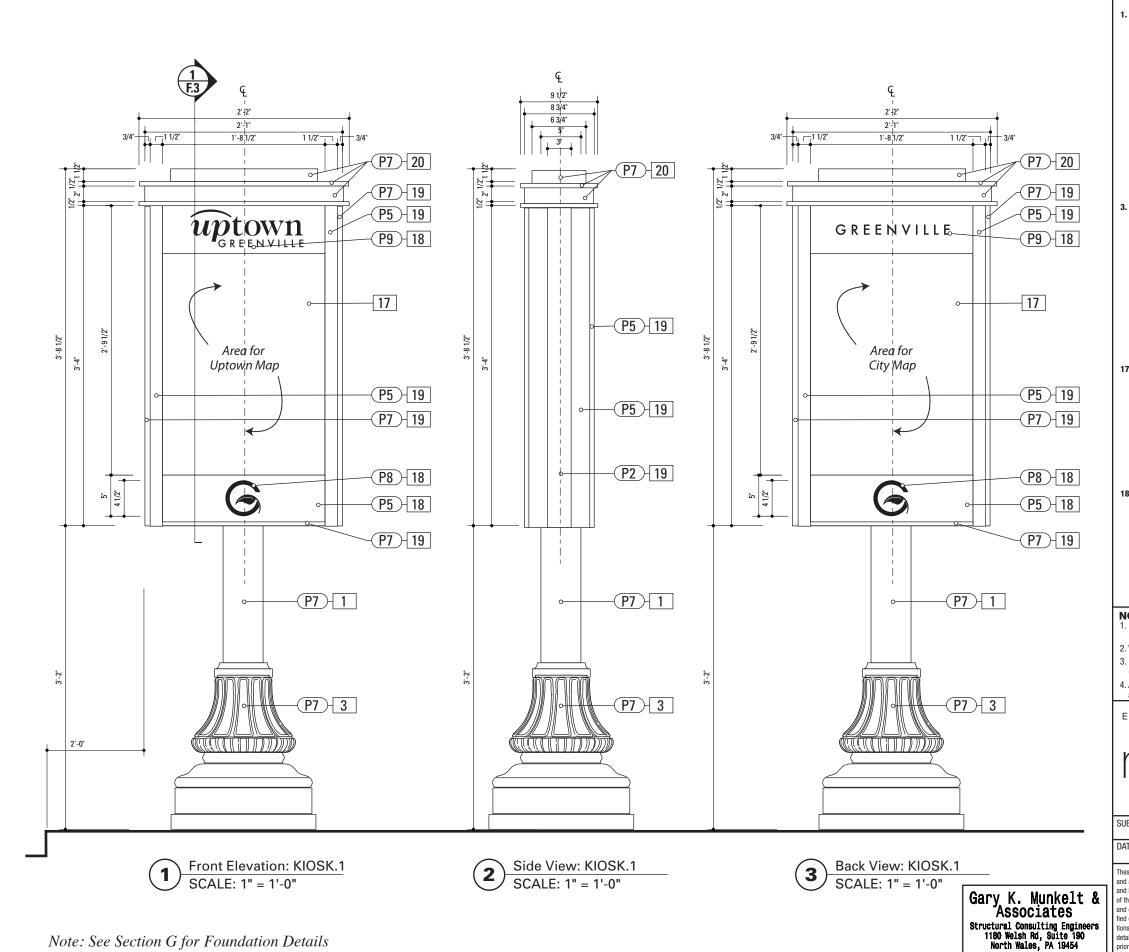

SPECIFICATIONS SIGN TYPE: KIOSK.1 FUNCTION: Pedestrian Kiosk

1. POI

POLE: 5" Nominal dia. OD. 5.563 Schedule 40 Wall Thickness 0.258 ID 5.047 MATERIAL: Aluminum

FABRICATION PROCESS: Extruded EDGES: Smooth COLOR: custom as noted

SURFACE PROCESS: Powdercoated - Finish: Factory Finish from Pole/Base Manufacturer.
CLEARCOAT: UV Anti/Graffiti

FOOTER: As per NCDOT Division 9 Breakaway specifications

No

The Pole should be fully fabricated/finished with mounting plate for future field replacement. Bench Stock pole length would match the tallest sign type and trimmed to size as replacements are needed.

3. DECORATIVE BASE

CAST: Wrap around 2 piece base.
Mechanically tightened.
MATERIAL: Aluminum
EDGES: Smooth
COLOR: Custom, as noted
SURFACE PROCESS: Powdercoated - Finish: Factory Finish

from Pole/Base Manufacturer.

CLEARCOAT: UV Anti/Graffiti
STYLF HADCO WAB 3000 Series or HAPCO Brand ARLEN or

approved equal.
FASTENER: Mechanically tightened around pole Contractor to provide rubber gaskets were base and pole meet for tight fit.
NOTE: A level concrete pad is to be formed to anchor the base, flush to grade.

17. GRAPHIC PANEL

PRODUCT: DIGITAL HIGH PRESSURE PHENOLIC LAMINATE GRADE:EXTERIOR

GRAPHIC APPROVAL SAMPLES: Submit 9 in x 15 in phenolic sample of section of typical project panel for approval of image quality and color fidelity.

WARRANTY PERIOD: Ten years from product ship date.

THICKNESS:1/8 inch
FINISH:Compatable UV inhibiting top layer

Provide Support Bracket or Panel behind Laminate to prevent pushout

18. SIGN PANEL MATERIAL: 1/4" thk Aluminum

FABRICATION PROCESS: Square Cut
EDGES: Smooth
COLOR: custom, as noted
SURFACE PROCESS: Paint all exposed surfaces
CLEARCOAT: UV Anti/Graffiti
FASTENER: Mechanically fasten to sign cabinet

Graphics/Logo Etched and Filled.

19. SIGN CABINET

I. SIGN CABINET

MATERIAL: 1/4" thk Aluminum

FABRICATION PROCESS: Fabricated

EDGES: Square

COLOR: custom, as noted

SURFACE PROCESS: Paint all exposed surfaces

CLEARCOAT: UV Anti/Graffiti

FASTENER: Mechanically fastened to pole

See Color Page for Specifications.

20. CABINET HEADER

MATERIAL: 1/4" thk Aluminum
FABRICATION PROCESS: Extruded/Fabricated
EDGES: Square
COLOR: custom, as noted
SURFACE PROCESS: Paint all exposed surfaces
CLEARCOAT: UV Anti/Graffiti
FASTENER: Mechanically fastened to sign cabinet

NOTE:

A seperate Spun Metal Base Cover hides couplings and is coordinated to fit around the Cast Metal Base to accommodate the Transpo Footer. (as shown in Bid Document Drawings.)

Providers of decorative bases (such as Hadco or Hapco) provide the sized pole that matches the opening of the Base. Shop Drawings from the pole/base provider are required for review and approval.

The design style suggested by the Contractor is subject to Designer/Owner review and approval. Finish: Factory Finish from Pole/Base Manufacturer.

DESIGN NOTE:

Final design and shop drawings shall be supplied by the fabricator. North Carolina registered professional engineer is required to sign and seal the submittal of shop drawings.


IOTES

y legal department

- Fabricator shall verify the mounting conditions and provide a detail drawing for each mounting situation, prior to fabrication.
 Fabricator shall obtain approval from the Designer or Client for placement prior to fabrication.
- 2. Welds: All welds shall be ground smooth, paint all seams.
- Hardware: All fasteners shall be concealed. If exposed, hardware shall be tamper proof fasteners, corrosion resistant, and color matching adjacent surfaces.
- 4. All painted sign surfaces to receive UV/Anti-Graffiti spray coating. All sign surfaces with reflective graphics to recieve 3M



01/31/2011

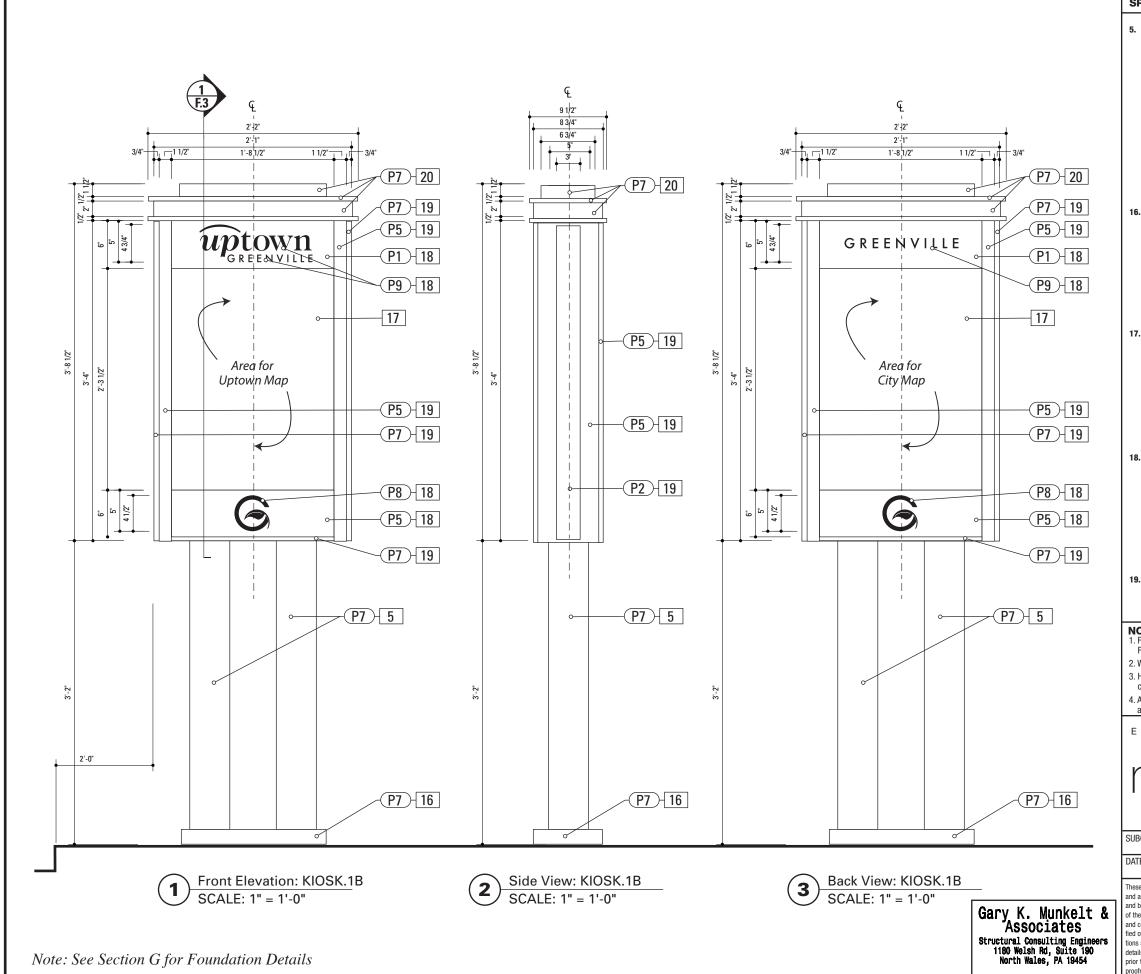

SPECIFICATIONS SIGN TYPE: KIOSK.1B FUNCTION: Pedestrian Kiosk

POLE: 1/4" thick aluminum MATERIAL: Aluminum SIZE: As shown FABRICATION PROCESS: Extruded

EDGES: Smooth COLOR: custom as noted SURFACE PROCESS: Paint all exposed surfaces

CLEARCOAT: UV Anti/Graffiti FOOTER: As per NCDOT Division 9 Breakaway specifications

The Pole should be fully fabricated/finished with mounting plate for future field replacement. Bench Stock pole length would match the tallest sign type and trimmed to size as replacements are needed.

16. BASE

MATERIAL: 1/4" thk Aluminum FABRICATION PROCESS: Fabricated SIZE: as required to cover FOOTER Assembly EDGES: Square COLOR: custom, as noted SURFACE PROCESS: Paint all exposed surfaces CLEARCOAT: Acrylic Polyurethane Clear Satin FOOTER: As per NCDOT Division 9 Breakaway specifications NOTE: A level concrete pad is to be formed to anchor the hase, flush to grade.

17. GRAPHIC PANEL

PRODUCT: DIGITAL HIGH PRESSURE PHENOLIC LAMINATE GRAPHIC APPROVAL SAMPLES: Submit 9 in x 15 in phenolic sample of section of typical project panel for approval of image quality and color fidelity.
WARRANTY PERIOD: Ten years from product ship date. THICKNESS:1/8 inch FINISH:Compatable UV inhibiting top layer Provide Support Bracket or Panel behind Laminate to prevent

18. SIGN PANEL

MATERIAL: 1/4" thk Aluminum FABRICATION PROCESS: Square Cut EDGES: Smooth COLOR: custom, as noted SURFACE PROCESS: Paint all exposed surfaces CLEARCOAT: UV Anti/Graffiti FASTENER: Mechanically fasten to sign cabinet

Graphics/Logo Etched and Filled See Color Page for Specifications

MATERIAL: 1/4" thk Aluminum FABRICATION PROCESS: Fabricated

EDGES: Square COLOR: custom, as noted SURFACE PROCESS: Paint all exposed surfaces CLEARCOAT: UV Anti/Graffiti FASTENER: Mechanically fastened to pole

20. CABINET HEADER

MATERIAL: 1/4" thk Aluminum FABRICATION PROCESS: Extruded/Fabricated EDGES: Square COLOR: custom, as noted SURFACE PROCESS: Paint all exposed surfaces CLEARCOAT: UV Anti/Graffiti FASTENER: Mechanically fastened to sign cabinet

DESIGN NOTE:


Final design and shop drawings shall be supplied by the fabricator. North Carolina registered professional engineer is required to sign and seal the submittal of shop drawings.

y legal department


- 1. Fabricator shall verify the mounting conditions and provide a detail drawing for each mounting situation, prior to fabrication. Fabricator shall obtain approval from the Designer or Client for placement prior to fabrication.
- 2. Welds: All welds shall be ground smooth, paint all seams.
- 3. Hardware: All fasteners shall be concealed. If exposed, hardware shall be tamper proof fasteners, corrosion resistant, and color matching adjacent surfaces.
- 4. All painted sign surfaces to receive UV/Anti-Graffiti spray coating. All sign surfaces with reflective graphics to recieve 3M



01/31/2011

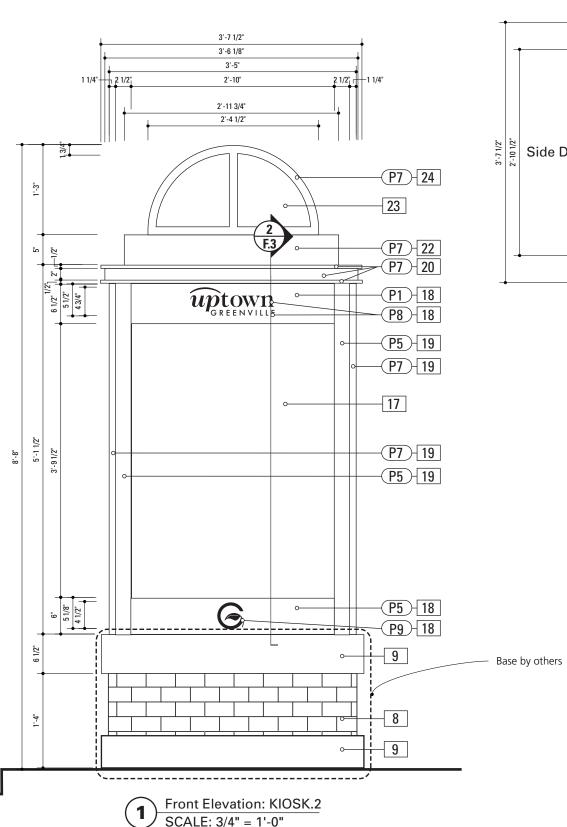

Note: See Section G for Foundation Details

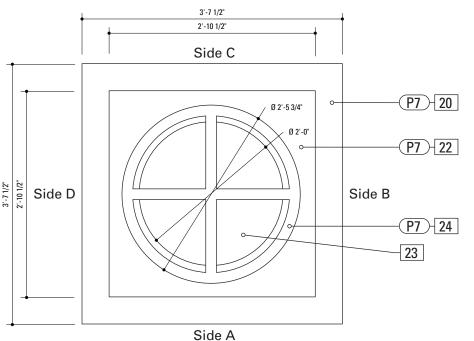

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Plan View: KIOSK.2

SCALE: 3/4" - 1'-0"

KIOSK.2 Content		
Side A	Uptown Map	
Side B	City Map	
Side C	Bulletin Board	
Side D	Poster / Advertisement	

Examples shown are strictly for design intent - color and look.

structural details, product type and construction details are the responsibility of the contractor. Product samples are to be provided to the designer/owner for review including sample of etched stone.

Brick: Mnf.-Acme Brick: Color/Style-Williamsburg Heritage or approved equal.

http://www.brick.com/cgi-bin/colorSelection.pl

Stone: Mnf.-Cold Spring Granite – Color/Style -Champaign *Mist or approved*

equal.

Finish: Diamond Ground

Graphic Sandblast Engraved Black Shadow.

Gary K. Munkelt & Associates Structural Consulting Engineers 1180 Welsh Rd, Suite 190 North Wales, PA 19454

SPECIFICATIONS SIGN TYPE: KIOSK.2

8. BRICK BASE

MATERIAL: Cinderblock base and brick to match uptown streetscape plan or approved equal FABRICATION PROCESS: Cinderblock base, cladded in brick EDGES: Square COLOR: Match Master Plan Specification FOOTER: Direct Burial J Bolt Ref Section F for details

PROVIDED BY OTHERS

MATERIAL: Stone to match untown streetscape plan or

9. STONE ACCENT

approved equal FABRICATION PROCESS: Match Master Plan Specification EDGES: Square CORNERS: Square COLOR: Stone Match Master Plan Specification FASTENER: Match Master Plan Specification PROVIDED BY OTHERS

17. GRAPHIC PANEL-Side A/B/D

PRODUCT: Professional Duratrans GRAPHIC APPROVAL SAMPLES: Submit 9 in x 15 sample of section of typical project panel for approval of image quality

WARRANTY PERIOD: MATERIAL: 10 years from product ship date. FADING 5 years THICKNESS:9ml

FINISH-LIV inhibiting top layer Contractor to supply fabrication details for adhering/holding

and changing graphic panel LIGHTING: Internally Illuminated - color temperature of 4000 \pm 1000 K, a Color Rendering Index (CRI) of 85 to 100, and an illuminance of at least 50 footcandles (538 lux). General Electric Deluxe Cool White Fluorescent Lamps (or similar lamps made by several manufacturers) meet these conditions. You can also use warmer lamps such as the Phillips 5000 K Ultralume, or a mixture of incandescent and fluorescent lamps. For each pair of 40-watt cool white deluxe fluorescent lamps, use a 75-watt frosted tungsten

17. GRAPHIC PANEL-Side C

PRODUCT NAME: Full Hinged Cabinet/Lockable outdoor corkboard display posters, schedules and notices MATERIAL: aluminum extrusions with rust resistant fasteners Two key locks - closed cell foam seal -impact resistant acrylic lens- rubber gasket seals between the door frame

18. SIGN PANEL MATERIAL: 1/4" thk Aluminum

FABRICATION PROCESS: Square Cut EDGES: Smooth SURFACE PROCESS: Paint all exposed surfaces CLEARCOAT: LIV Anti/Graffiti FASTENER: Mechanically fasten to sign cabinet

Graphics/Logo Etched and Filled.

19. SIGN CABINET

MATERIAI · 1/4" thk Aluminum FABRICATION PROCESS: Fabricated EDGES: Square COLOR: custom, as noted SURFACE PROCESS: Paint all exposed surfaces CLEARCOAT: UV Anti/Graffiti

FUNCTION: Pedestrian Kiosk

FASTENER: Mechanically fastened to pole **20. CABINET HEADER**

MATERIAL · 1/4" thk Aluminum

MATERIAL · 1/4" thk Aluminum

FABRICATION PROCESS: Fabricated

FABRICATION PROCESS: Extruded/Fabricated FDGFS: Square COLOR: custom, as noted SURFACE PROCESS: Paint all exposed surfaces CLEARCOAT: UV Anti/Graffiti FASTENER: Mechanically fastened to sign cabinet

22. LIGHTING CABINET

FDGFS: Square COLOR: custom, as noted SURFACE PROCESS: Paint all exposed surfaces CLEARCOAT: UV Anti/Graffiti FASTENER: Mechanically fastened to cabinet header LIGHTING: Contractor to Provide exact number of fixtures to provide even illumination without shadows or hotspots. Power Requirement: 120 V

Power to be provided by others Stubbed through Base Unit 23. DOME

MATERIAL: 1/4" translucent frosted white cast acrylic dome or approved equal. Manufactirer to provide spec and warren ty information for review and approval. FABRICATION PROCESS: Extruded/Fabricated

FDGFS: Smooth COLOR: translucent frosted white: Milk Glass CLEARCOAT: Acrylic Polyurethane Clear Satin FASTENER: Mechanically fastened to lighting cabinet LIGHTING: Internally illuminated with LED fixture(s) Contractor to Provide exact number of fixtures to provide even illumination without shadows or hotspots. Power Requirement: 120 V

Power to be provided by others within 5 feet of Unit

24. DOME ACCENTS


MATERIAL · 1/4" thk Aluminum bar stock FABRICATION PROCESS: Extruded/Cut/Formed EDGES: Smooth COLOR: custom, as noted FASTENER: mechanically fasten to lighting cabinet

DESIGN NOTE:


Final design and shop drawings shall be supplied by the fabricator. North Carolina registered professiona engineer is required to sign and seal the submittal of shop drawings.

- 1. Fabricator shall verify the mounting conditions and provide a detail drawing for each mounting situation, prior to fabrication Fabricator shall obtain approval from the Designer or Client for placement prior to fabrication.
- 2. Welds: All welds shall be ground smooth, paint all seams.
- 3. Hardware: All fasteners shall be concealed. If exposed, hardware shall be tamper proof fasteners, corrosion resistant, and color matching adjacent surfaces.
- 4. All painted sign surfaces to receive UV/Anti-Graffiti spray coating. All sign surfaces with reflective graphics to recieve 3M



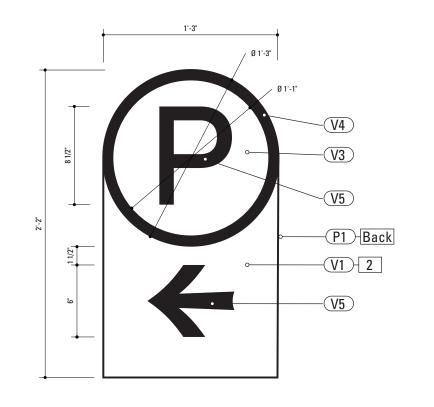

Graphic Layout: PARK.1 SCALE: 1 1/2" = 1'-0"

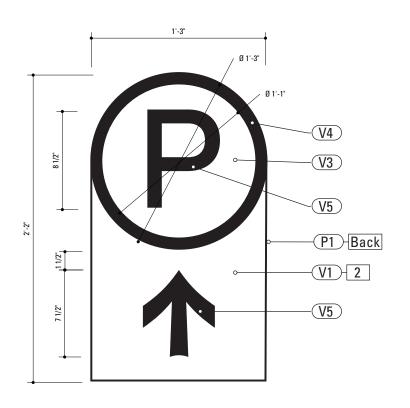

Graphic Layout: PARK.1 SCALE: 1 1/2" = 1'-0"

Gary K. Munkelt & Associates Structural Consulting Engineers 1180 Welsh Rd, Suite 190 North Wales, PA 19454

Phone 215-855-8713 Fax 215-855-8714

SPECIFICATIONS SIGN TYPE: PARK.1 **FUNCTION:** Parking Directional

POLE: 5" dia. 1/4" thick aluminum MATERIAL: Aluminum FABRICATION PROCESS: Extruded EDGES: Smooth COLOR: custom as noted SURFACE PROCESS: Paint all exposed surfaces CLEARCOAT: UV Anti/Graffiti FOOTER: As per NCDOT Division 9 Breakaway specifications

The Pole should be fully fabricated/finished with mounting plate for future field replacement. Bench Stock pole length would match the tallest sign type and trimmed to size as replacements are needed.

2. SIGN PANEL - REFLECTIVE VINYL MATERIAL · 1/4" thk Aluminu

FABRICATION PROCESS: Router Cut FDGFS: Smooth COLOR: Custom, as noted GRAPHIC BACKGROUND AND COPY PROCESS: 3M custom screened inks print direct to 3930 with 3M approved UV/ Graffiti Vinyl Over-laminates. (See Color Sheet A6 for all color and material specifications) FASTENER: Mechanical

Reflective Vinyl Graphics applied to front face of Sign Panel. See Color Page for Specifications.

MATERIAL: 1/4" thk Aluminum FABRICATION PROCESS: Extruded EDGES: Square COLOR: custom, as noted SURFACE PROCESS: Paint all exposed surfaces CLEARCOAT: UV Anti/Graffiti FASTENER: Mechanically fastened to pole

30. BREAKAWAY FOOTER


Product: TRANSPO Breakaway sign support system or NCDOT Approved equal Type: Male/Female Coupling assembly. Base Plate welded to pole.
Size and specs to be determined by Contractors structural NOTE: All signs are positioned within NCDOT R.O.W. and shall be breakaway as per NCDOT Division 9 Breakaway specifica-

DESIGN NOTE:

Final design and shop drawings shall be supplied by the fabricator. North Carolina registered professional engineer is required to sign and seal the submittal of shop drawings.


- 1. Fabricator shall verify the mounting conditions and provide a detail drawing for each mounting situation, prior to fabrication. Fabricator shall obtain approval from the Designer or Client for placement prior to fabrication.
- 2. Welds: All welds shall be ground smooth, paint all seams.
- $3. \ Hardware: All \ fasteners \ shall \ be \ concealed. \ If \ exposed, hardware \ shall \ be \ tamper \ proof \ fasteners, corrosion \ resistant, \ and$ color matching adjacent surfaces.
- 4. All painted sign surfaces to receive UV/Anti-Graffiti spray coating. All sign surfaces with reflective graphics to recieve 3M




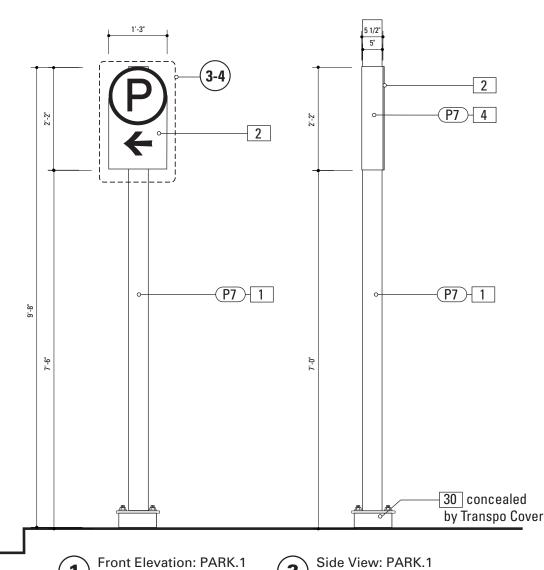

SCALE: 1/2" = 1'-0"


SCALE: 1/2" = 1'-0"

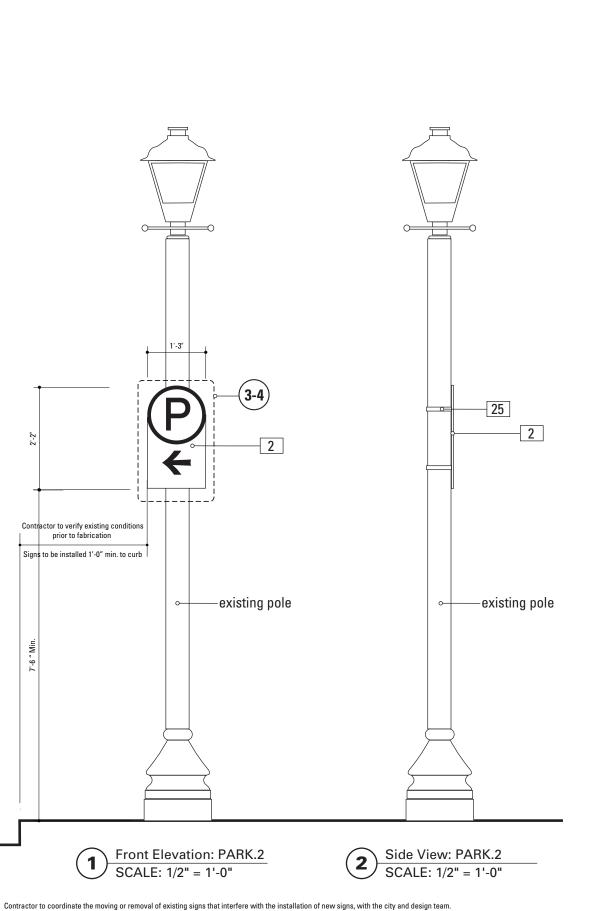

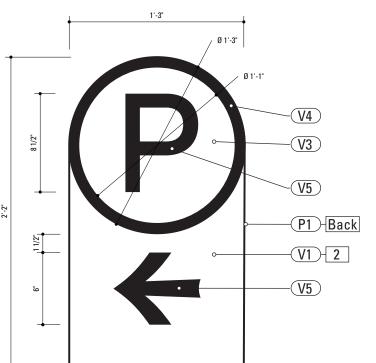

Graphic Layout: PARK.2

SCALE: 1 1/2" = 1'-0"

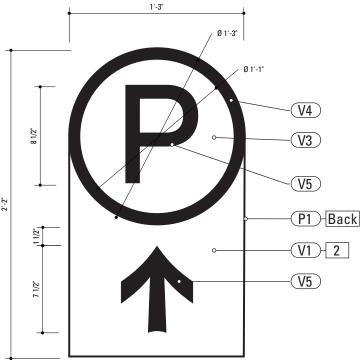

Graphic Layout: PARK.2

SCALE: 1 1/2" = 1'-0"

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Structural Consulting Engineers
1180 Welsh Rd, Suite 190
North Wales, PA 19454

Phone 215-855-8713 Fax 215-855-8714 by

SPECIFICATIONS SIGN TYPE: PARK.2

2. SIGN PANEL - REFLECTIVE VINYL
MATERIAL: 1/4" thik Aluminum
FABRICATION PROCESS: Router Cut
EDGES: Smooth
COLOR: Custom, as noted
GRAPHIC BACKGROUND AND COPY PROCESS: 3M custom
inks print direct to 3930 with 3M approved UV/Graffiti Vinyl
Over-laminates. (See Color Sheet A6 for all color and material

FASTENER: Mechanically Fastened to Strap Bracket.

25. STRAP
MATERIAL: Stainless steel with threaded tightening assembly

including hardware
MOUNTING: Adjustable for utility and street poles (round square up to 10" dia.)
COLOR: Match pole finish. Black for black or dark colored poles. Stainless steel for light or stainless steel poles.
QUANTITY: 3 per sign
HARDWARE: As required – located on panel not interfere with graphic sign elements.

NOTE: Sign Contractor to coordinate the removal or movement of interfearing existing signs on poles, with

DESIGN NOTE:


FUNCTION: Parking Directional

Final design and shop drawings shall be supplied by the fabricator. North Carolina registered professional engineer is required to sign and seal the submittal of shop drawings.

NOTES

- Fabricator shall verify the mounting conditions and provide a detail drawing for each mounting situation, prior to fabrication.
 Fabricator shall obtain approval from the Designer or Client for placement prior to fabrication.
- 2. Welds: All welds shall be ground smooth, paint all seams.
- 3. Hardware: All fasteners shall be concealed. If exposed, hardware shall be tamper proof fasteners, corrosion resistant, and color matching adjacent surfaces.
- All painted sign surfaces to receive UV/Anti-Graffiti spray coating. All sign surfaces with reflective graphics to recieve 3M approved UV/Anti-Graffiti overlaminate.



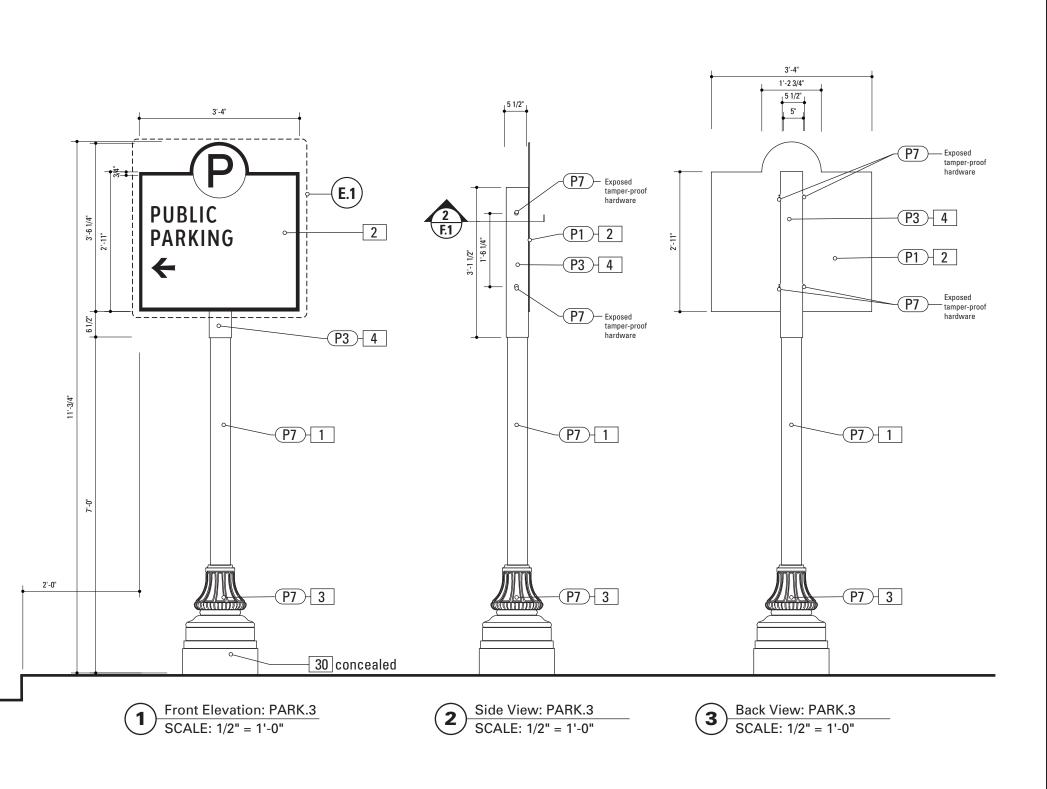

SPECIFICATIONS SIGN TYPE: PARK.3 FUNCTION: Parking Directional

1. P

POLE: 5" Nominal dia. OD. 5.563 Schedule 40 Wall Thickness 0.258 ID 5.047 MATERIAL Aluminum

FABRICATION PROCESS: Extruded EDGES: Smooth

COLOR: custom as noted SURFACE PROCESS: Powdercoated - Finish: Factory Finish from Pole/Base Manufacturer.

CLEARCOAT: UV Anti/Graffiti FOOTER: As per NCDOT Division 9 Breakaway specifications

Note:

The Pole should be fully fabricated/finished with mounting plate for future field replacement. Bench Stock pole length would match the tallest sign type and trimmed to size as replacements are needed.

2. SIGN PANEL - REFLECTIVE VINYL

MATERIAL: 1/4" thk Aluminum
FABRICATION PROCESS: Router Cut
EDGES: Smooth
COLOR: Custom, as noted
GRAPHIC BACKGROUND AND COPY PROCESS: 3M custom
screened inks print direct to 3930 with 3M approved UV/
Graffiti Vinyl Over-laminates. (See Color Sheet A6 for all color
and material specifications)
FASTENER: Mechanical
Reflective Vinyl Graphics applied to front face of Sign Panel.
See Color Page for Specifications.

3. DECORATIVE BASE

CAST: Wrap around 2 piece base.
Mechanically tightened.
MATERIAL: Aluminum
EDGES: Smooth
COLOR: Custom, as noted
SURFACE PROCESS: Powdercoated - Finish: Factory Finish
from Pole/Base Manufacturer.
CLEARCOAT: UV Anti/Graffiti
STYLE: HADCO WAB 3000 Series or HAPCO Brand ARLEN. or

approved equal. FASTENER: Mechanically tightened around pole Contractor to provide rubber gaskets were base and pole meet for tight fit. NOTE: A level concrete pad is to be formed to anchor the base, flush to grade.

4. SLEEVE

MATERIAL: 1/4" thk Aluminum
FABRICATION PROCESS: Extruded
EDGES: Square
COLOR: custom, as noted
SURFACE PROCESS: Paint all exposed surfaces
CLEARCOAT: UV Anti/Graffiti
FASTENER: Mechanically fastened to pole

30. BREAKAWAY FOOTER

Product: TRANSPO Breakaway sign support system or NCDOT

DESIGN NOTE:

Type: Male/Female Coupling assembly.

Size and specs to be determined by Contractors structural

NOTE: All signs are positioned within NCDOT R.O.W. and shall

be breakaway as per NCDOT Division 9 Breakaway specifica-

Seperate Spun Metal Base Cover hides couplings.

Finish: Factory Finish from Pole/Base Manufacturer.

A seperate Spun Metal Base Cover hides couplings and is

coordinated to fit around the Cast Metal Base to accommodate the Transpo Footer. (as shown in Bid Document

Providers of decorative bases (such as Hadco or Hapco)

provide the sized pole that matches the opening of the Base.

Shop Drawings from the pole/base provider are required for

The design style suggested by the Contractor is subject to

Designer/Owner review and approval. Finish: Factory Finish

Base Plate welded to pole.

NOTE:

Drawings.)

review and approval.

from Pole/Base Manufacturer.


Final design and shop drawings shall be supplied by the fabricator. North Carolina registered professional engineer is required to sign and seal the submittal of shop drawings.

NOTES

- 1. Fabricator shall verify the mounting conditions and provide a detail drawing for each mounting situation, prior to fabrication. Fabricator shall obtain approval from the Designer or Client for placement prior to fabrication.
- 2. Welds: All welds shall be ground smooth, paint all seams.
- 3. Hardware: All fasteners shall be concealed. If exposed, hardware shall be tamper proof fasteners, corrosion resistant, and color matching adjacent surfaces.
- 4. All painted sign surfaces to receive UV/Anti-Graffiti spray coating. All sign surfaces with reflective graphics to recieve 3M



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North Wales, PA 19454

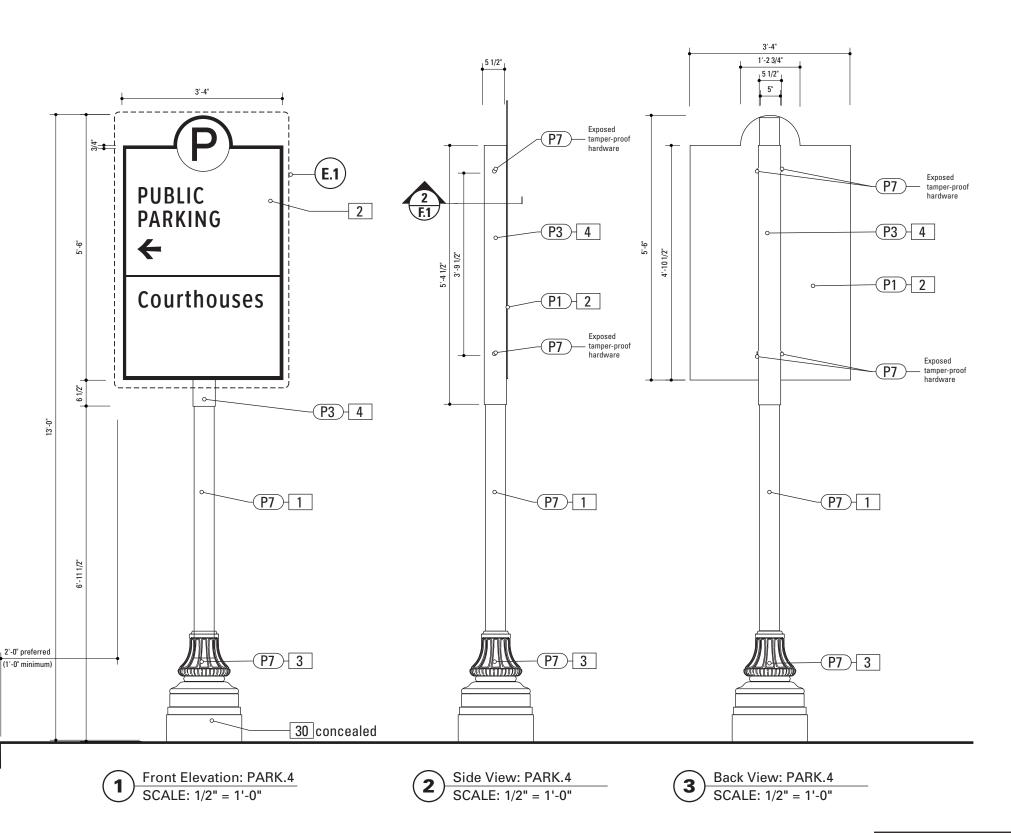

SPECIFICATIONS SIGN TYPE: PARK.4 **FUNCTION:** Parking Directional

Approved equal

NOTE:

Drawings.)

review and approval.

from Pole/Base Manufacturer

Base Plate welded to pole.

Type: Male/Female Coupling assembly.

Size and specs to be determined by Contractors structural

NOTE: All signs are positioned within NCDOT R.O.W. and shall

be breakaway as per NCDOT Division 9 Breakaway specifica-

Seperate Spun Metal Base Cover hides couplings.

Finish: Factory Finish from Pole/Base Manufacturer.

A seperate Spun Metal Base Cover hides couplings and is

coordinated to fit around the Cast Metal Base to accom-

modate the Transpo Footer, (as shown in Bid Document

Providers of decorative bases (such as Hadco or Hapco)

provide the sized pole that matches the opening of the Base.

Shop Drawings from the pole/base provider are required for

The design style suggested by the Contractor is subject to

Designer/Owner review and approval. Finish: Factory Finish

POLE: 5" Nominal dia. OD. 5.563 Schedule 40 Wall Thickness 0.258 ID 5.047 MATERIAL: Aluminum FABRICATION PROCESS: Extruded

EDGES: Smooth COLOR: custom as noted

SURFACE PROCESS: Powdercoated - Finish: Factory Finish from Pole/Base Manufacturer. CLEARCOAT: UV Anti/Graffiti

FOOTER: As per NCDOT Division 9 Breakaway specifications

The Pole should be fully fabricated/finished with mounting plate for future field replacement. Bench Stock pole length would match the tallest sign type and trimmed to size as replacements are needed.

SIGN PANEL - REFLECTIVE VINYL

MATERIAL: 1/4" thk Aluminum FABRICATION PROCESS: Router Cut FDGFS: Smooth COLOR: Custom, as noted GRAPHIC BACKGROUND AND COPY PROCESS: 3M custom screened inks print direct to 3930 with 3M approved UV/ Graffiti Vinyl Over-laminates. (See Color Sheet A6 for all color and material specifications) FASTENER: Mechanical Reflective Vinyl Graphics applied to front face of Sign Panel.

DECORATIVE BASE

CAST: Wrap around 2 piece base. Mechanically tightened. MATERIAL: Aluminum EDGES: Smooth COLOR: Custom, as noted SURFACE PROCESS: Powdercoated - Finish: Factory Finish from Pole/Base Manufacturer. CLEARCOAT: UV Anti/Graffiti

See Color Page for Specifications.

STYLE: HADCO WAB 3000 Series or HAPCO Brand ARLEN. or approved equal.

FASTENER: Mechanically tightened around pole Contractor to provide rubber gaskets were base and pole meet for tight fit. NOTE: A level concrete pad is to be formed to anchor the base, flush to grade.

SLEEVE

MATERIAL: 1/4" thk Aluminum FABRICATION PROCESS: Extruded EDGES: Square COLOR: custom, as noted SURFACE PROCESS: Paint all exposed surfaces CLEARCOAT: UV Anti/Graffiti FASTENER: Mechanically fastened to pole

30. BREAKAWAY FOOTER

Product: TRANSPO Breakaway sign support system or NCDOT

DESIGN NOTE:


Final design and shop drawings shall be supplied by the fabricator. North Carolina registered professional engineer is required to sign and seal the submittal of shop drawings.

- 1. Fabricator shall verify the mounting conditions and provide a detail drawing for each mounting situation, prior to fabrication. Fabricator shall obtain approval from the Designer or Client for placement prior to fabrication.
- 2. Welds: All welds shall be ground smooth, paint all seams.
- 3. Hardware: All fasteners shall be concealed. If exposed, hardware shall be tamper proof fasteners, corrosion resistant, and color matching adjacent surfaces.
- 4. All painted sign surfaces to receive UV/Anti-Graffiti spray coating. All sign surfaces with reflective graphics to recieve 3M



01/31/2011

Gary K. Munkelt & Associates Structural Consulting Engineers 1180 Welsh Rd, Suite 190 North Wales, PA 19454

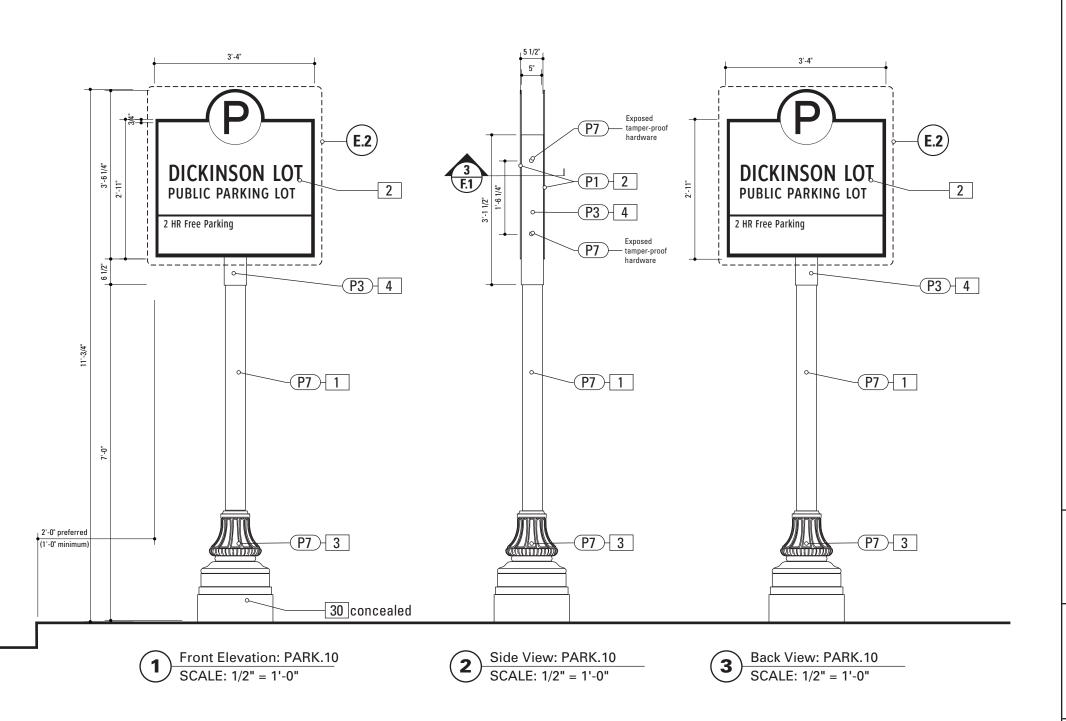

SPECIFICATIONS SIGN TYPE: PARK.10

1. POLE

POLE: 5" Nominal dia. OD. 5.563 Schedule 40 Wall Thickness 0.258 ID 5.047

MATERIAL: Aluminum FABRICATION PROCESS: Extruded

EDGES: Smooth

CULOR: custom as noted SURFACE PROCESS: Powdercoated - Finish: Factory Finish

from Pole/Base Manufacturer. CLEARCOAT: UV Anti/Graffiti

FOOTER: As per NCDOT Division 9 Breakaway specifications

Note:

The Pole should be fully fabricated/finished with mounting plate for future field replacement. Bench Stock pole length would match the tallest sign type and trimmed to size as replacements are needed.

2. SIGN PANEL - REFLECTIVE VINYL

MATERIAL: 1/4" thk Aluminum
FARRICATION PROCESS: Router Cut

EDGES: Smooth

COLOR: Custom, as noted GRAPHIC BACKGROUND AND COPY PROCESS: 3M custom screened inks print direct to 3930 with 3M approved UV/ Graffiti Vinyl Over-laminates. (See Color Sheet A6 for all color

and material specifications)
FASTENER: Mechanical

Reflective Vinyl Graphics applied to front face of Sign Panel. See Color Page for Specifications.

B. DECORATIVE BASE

CAST: Wrap around 2 piece base. Mechanically tightened. MATERIAL: Aluminum

EDGES: Smooth

SURFACE PROCESS: Powdercoated - Finish: Factory Finish from Pole/Base Manufacturer

CLEARCOAT: UV Anti/Graffiti

STYLE: HADCO WAB 3000 Series or HAPCO Brand ARLEN. or approved equal.

FASTENER: Mechanically tightened around pole Contractor to provide rubber gaskets were base and pole meet for tight fit. NOTE: A level concrete pad is to be formed to anchor the base, flush to grade.

4. SLEEVE

MATERIAL: 1/4" thk Aluminum
FABRICATION PROCESS: Extruded
EDGES: Square
COLOR: custom, as noted
SURFACE PROCESS: Paint all exposed surfaces

CLEARCOAT: UV Anti/Graffiti
FASTENER: Mechanically fastened to pole

30. BREAKAWAY FOOTER

proofread by client and legal requirements checked

y legal department

Product: TRANSPO Breakaway sign support system or NCDOT

Approved equal

Type: Male/Female Coupling assembly. Base Plate welded to pole.

Size and specs to be determined by Contractors structural

engineer.

NOTE: All signs are positioned within NCDOT R.O.W. and shall be breakaway as per NCDOT Division 9 Breakaway specifica-

FUNCTION: Parking Identification

Seperate Spun Metal Base Cover hides couplings.

Finish: Factory Finish from Pole/Base Manufacturer.

NOTE:

A seperate Spun Metal Base Cover hides couplings and is coordinated to fit around the Cast Metal Base to accommodate the Transpo Footer. (as shown in Bid Document Drawings.)

Providers of decorative bases (such as Hadco or Hapco) provide the sized pole that matches the opening of the Base. Shop Drawings from the pole/base provider are required for review and approval.

The design style suggested by the Contractor is subject to Designer/Owner review and approval. Finish: Factory Finish from Pole/Base Manufacturer.

DESIGN NOTE:

Final design and shop drawings shall be supplied by the fabricator. North Carolina registered professional engineer is required to sign and seal the submittal of shop drawings.


NOTES

- Fabricator shall verify the mounting conditions and provide a detail drawing for each mounting situation, prior to fabrication.
 Fabricator shall obtain approval from the Designer or Client for placement prior to fabrication.
- 2. Welds: All welds shall be ground smooth, paint all seams.
- 3. Hardware: All fasteners shall be concealed. If exposed, hardware shall be tamper proof fasteners, corrosion resistant, and color matching adjacent surfaces.
- 4. All painted sign surfaces to receive UV/Anti-Graffiti spray coating. All sign surfaces with reflective graphics to recieve 3M approved III//Anti-Graffiti overlaminate



01/31/2011

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Structural Consulting Engineers
1180 Welsh Rd, Suite 190
North Wales, PA 19454

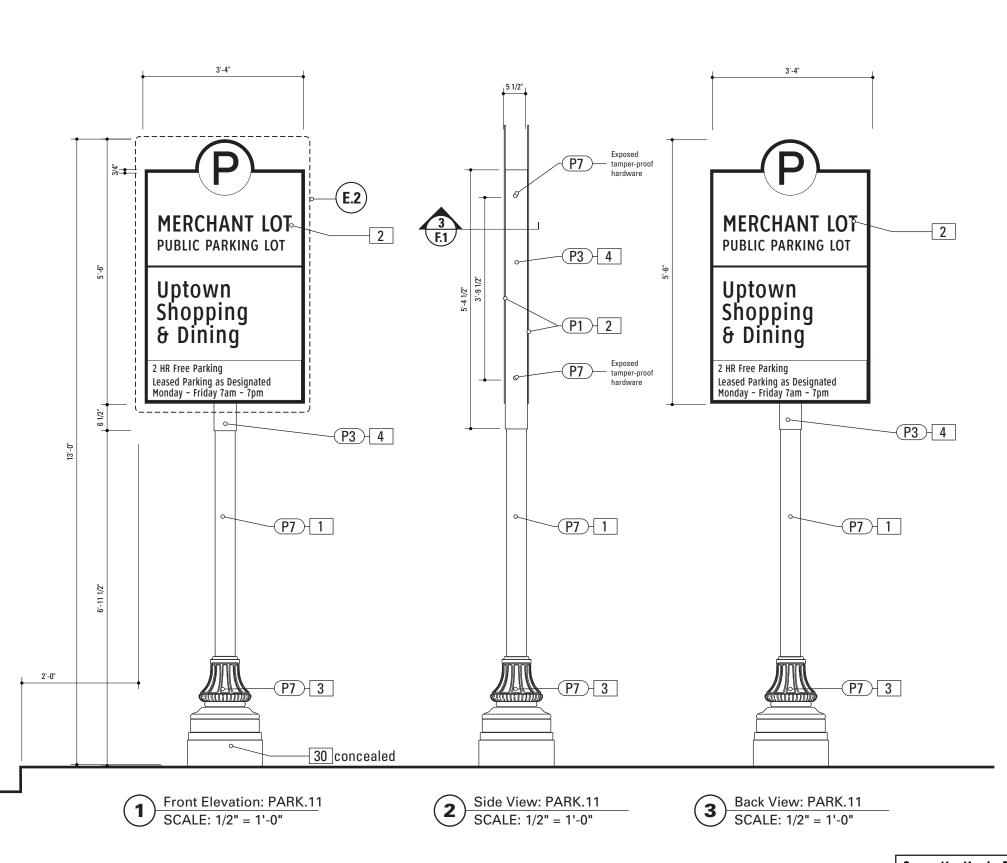

Gary K. Munkelt & Associates Structural Consulting Engineers 1180 Welsh Rd, Suite 190 North Wales, PA 19454

proofread by client and legal requirements checked Phone 215-855-8713 Fax 215-855-8714

SPECIFICATIONS SIGN TYPE: PARK.11

1. POLE

POLE: 5" Nominal dia OD. 5.563 Schedule 40 Wall Thickness 0.258 ID 5.047 MATERIAL: Aluminum

FABRICATION PROCESS: Extruded

EDGES: Smooth

COLOR: custom as noted

SURFACE PROCESS: Powdercoated - Finish: Factory Finish from Pole/Base Manufacturer. CLEARCOAT: UV Anti/Graffiti

FOOTER: As per NCDOT Division 9 Breakaway specifications

The Pole should be fully fabricated/finished with mounting plate for future field replacement. Bench Stock pole length would match the tallest sign type and trimmed to size as replacements are needed.

2. SIGN PANEL - REFLECTIVE VINYL

MATERIAL: 1/4" thk Aluminum FABRICATION PROCESS: Router Cut

EDGES: Smooth COLOR: Custom, as noted

GRAPHIC BACKGROUND AND COPY PROCESS: 3M custom screened inks print direct to 3930 with 3M approved UV/ Graffiti Vinyl Over-laminates (See Color Sheet A6 for all color

and material specifications) FASTENER: Mechanical

Reflective Vinyl Graphics applied to front face of Sign Panel. See Color Page for Specifications.

DECORATIVE BASE

CAST: Wrap around 2 piece base. Mechanically tightened MATERIAL: Aluminum

EDGES: Smooth COLOR: Custom, as noted

SURFACE PROCESS: Powdercoated - Finish: Factory Finish

from Pole/Base Manufacturer. CLEARCOAT: UV Anti/Graffiti

STYLE: HADCO WAB 3000 Series or HAPCO Brand ARLEN. or approved equal

FASTENER: Mechanically tightened around pole Contractor to provide rubber gaskets were base and pole meet for tight fit. NOTE: A level concrete pad is to be formed to anchor the

base, flush to grade.

SLEEVE

MATERIAL: 1/4" thk Aluminum FABRICATION PROCESS: Extruded EDGES: Square

COLOR: custom, as noted SURFACE PROCESS: Paint all exposed surfaces CLEARCOAT: UV Anti/Graffiti

FASTENER: Mechanically fastened to pole

30. BREAKAWAY FOOTER

Product: TRANSPO Breakaway sign support system or NCDOT

DESIGN NOTE:

FUNCTION: Parking Directional

Size and specs to be determined by Contractors structural

NOTE: All signs are positioned within NCDOT R.O.W. and shall

be breakaway as per NCDOT Division 9 Breakaway specifica-

Seperate Spun Metal Base Cover hides couplings.

Finish: Factory Finish from Pole/Base Manufacturer.

A seperate Spun Metal Base Cover hides couplings and is

coordinated to fit around the Cast Metal Base to accom-

Providers of decorative bases (such as Hadco or Hapco)

provide the sized pole that matches the opening of the Base.

Shop Drawings from the pole/base provider are required for

The design style suggested by the Contractor is subject to

Designer/Owner review and approval. Finish: Factory Finish

modate the Transpo Footer, (as shown in Bid Document

Approved equal

Base Plate welded to pole.

review and approval.

from Pole/Base Manufacturer.

Type: Male/Female Coupling assembly.

Final design and shop drawings shall be supplied by the fabricator. North Carolina registered professional engineer is required to sign and seal the submittal of shop drawings.

y legal department.

1. Fabricator shall verify the mounting conditions and provide a detail drawing for each mounting situation, prior to fabrication. Fabricator shall obtain approval from the Designer or Client for placement prior to fabrication.

2. Welds: All welds shall be ground smooth, paint all seams.

3. Hardware: All fasteners shall be concealed. If exposed, hardware shall be tamper proof fasteners, corrosion resistant, and color matching adjacent surfaces.

4. All painted sign surfaces to receive UV/Anti-Graffiti spray coating. All sign surfaces with reflective graphics to recieve 3M

ENVIRONMENTS & EXPERIENCES 120 North Church Street Suite 208 merje West Chester, PA 19380 T 484.266.0648 www.merjedesign.com SUBCONSULTANT 6/30/2009

CLIENT / PROJECT Clty of Greenville, NC

> City of Greenville, NC Wayfinding and Signage

PROJECT NO. Y41-07963


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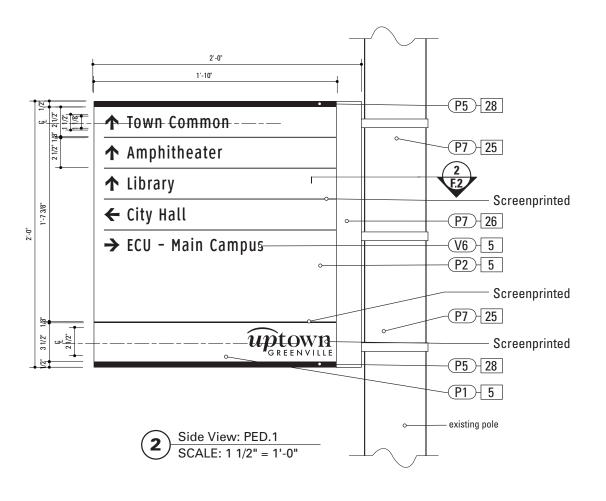
DRAWN BY: KB/GS These drawings are meant for DESIGN INTENT ONLY REVISIONS and are not for construction. Contractor shall verify and be responsible for all dimensions and condition of the job. Contractor shall be familiar with the site 05/22/2010 and conditions it presents. This office must be noti-SHEET NO. fied of any variations from the dimensions and cond 08/06/2010 tions shown on this drawing. Shop drawings and details must be submitted to this office for approval prior to proceeding with fabrication. All copy shall be 09/01/2010

01/31/2011

Sign Type PARK.11 **Parking Identification**

D.19



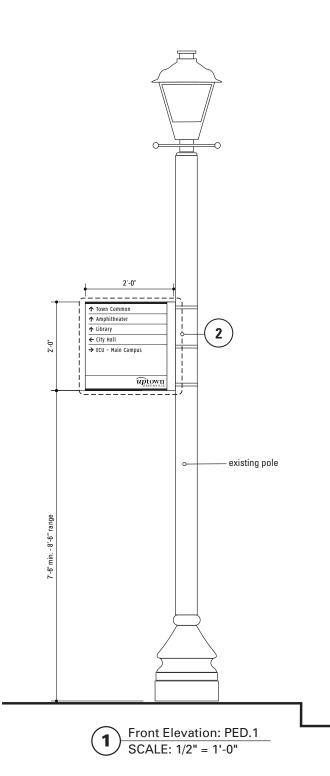

SPECIFICATIONS SIGN TYPE: PED.1

MATERIAL: 1/4" thk Aluminum FABRICATION PROCESS: Square Cut

EDGES: Square COLOR: custom, as noted SURFACE PROCESS: Paint all exposed surfaces

CLEARCOAT: UV Anti/Graffiti FASTENER: Mechanically fastened to U-Channel

FASTENER: Mechanically fastened to U-SIDES: A and B - Double sided

See Color Page for Specifications.

Vinyl Graphics applied to front face of Sign Panel.
"Uptown Greenville" Logo Portion to be screenprinted.

25. STRA

5. SIGN PANEL

MATERIAL: Stainless steel with threaded tightening assembly including hardware MOUNTING: Adjustable for utility and street poles (round

square up to 10" dia.)
COLOR: Match pole finish. Black for black or dark colored

poles. Stainless steel for light or stainless steel poles.

QUANTITY: 3 per sign

HARDWARE: As required - located on panel not interfere with graphic sign elements.

NOTE: Sign Contractor to coordinate the removal or movement of interfearing existing signs on poles, with the city.

26. U-CHANNEL

MATERIAL: 1/4" thk Aluminum U-Channels FABRICATION PROCESS: Extruded EDGES: square COLOR: custom, as noted SURFACE PROCESS: Paint all exposed surfaces CLEARCOAT: UV Anti/Graffiti FASTENER: Mechanically fastened to Strap

28. ACCENT BAR

MATERIAL: 1/4" thick Aluminum bar stock FABRICATION PROCESS: Extruded / Cut EDGES: Square COLOR: custom, as noted SURFACE PROCESS: Paint all exposed surfaces CLEARCOAT: UV Anti/Graffiti FASTENER: mechanically fasten to sign panel

DESIGN NOTE:

Final design and shop drawings shall be supplied by the fabricator. North Carolina registered professional engineer is required to sign and seal the submittal of shop drawings.

FUNCTION: Pedestrian Directional

NOTES


y legal department.

- Fabricator shall verify the mounting conditions and provide a detail drawing for each mounting situation, prior to fabrication.
 Fabricator shall obtain approval from the Designer or Client for placement prior to fabrication.
- 2. Welds: All welds shall be ground smooth, paint all seams.
- 3. Hardware: All fasteners shall be concealed. If exposed, hardware shall be tamper proof fasteners, corrosion resistant, and color matching adjacent surfaces.
- 4. All painted sign surfaces to receive UV/Anti-Graffiti spray coating. All sign surfaces with reflective graphics to recieve 3M

CLIENT / PROJECT ENVIRONMENTS & EXPERIENCES Clty of Greenville, NC 120 North Church Street City of Greenville, NC Suite 208 **Wayfinding and Signage** West Chester, PA 19380 T 484.266.0648 www.merjedesign.com PROJECT NO. Y41-07963 SUBCONSULTANT SHEET TITLE DRAWN BY: 6/30/2009 KB/GS Sign Type PED.1 These drawings are meant for DESIGN INTENT ONLY REVISIONS **Pedestrian Directional** and are not for construction. Contractor shall verify and be responsible for all dimensions and condition of the job. Contractor shall be familiar with the site 05/22/2010 and conditions it presents. This office must be noti-SHEET NO. fied of any variations from the dimensions and cond 08/06/2010 tions shown on this drawing. Shop drawings and details must be submitted to this office for approval **D.20** prior to proceeding with fabrication. All copy shall be 09/01/2010 proofread by client and legal requirements checked

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Structural Consulting Engineers
1180 Welsh Rd, Suite 190
North Wales, PA 19454

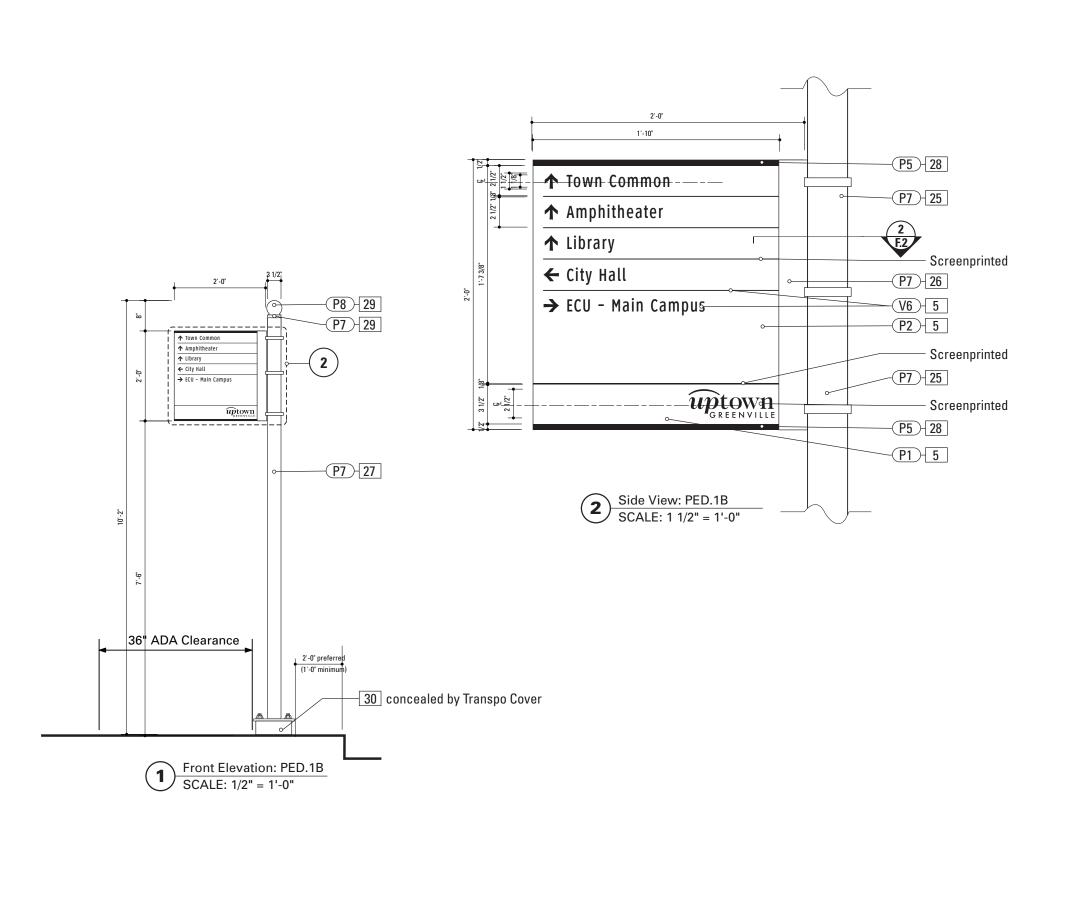

SPECIFICATIONS SIGN TYPE: PED.1B

5. SIGN PANEL

FABRICATION PROCESS: Square Cut EDGES: Square COLOR: custom, as noted SURFACE PROCESS: Paint all exposed surfaces CLEARCOAT: UV Anti/Graffiti FASTENER: Mechanically fastened to U-Channel SIDES: A and B - Double sided Vinyl Graphics applied to front face of Sign Panel. "Uptown Greenville" Logo Portion to be screenprinted.

MATERIAL: 1/4" thk Aluminum

See Color Page for Specifications.

25. STRA

MATERIAL: Stainless steel with threaded tightening assembly including hardware
MOUNTING: Adjustable for utility and street poles (round square up to 10" dia.)
COLOR: Match pole finish Black
QUANTITY: 3 per sign
HARDWARE: As required - located on panel not interfere with graphic sign elements.

26. U-CHANNEL

MATERIAL: 1/4" thk Aluminum U-Channels
FABRICATION PROCESS: Extruded
EDGES: square
COLOR: custom, as noted
SURFACE PROCESS: Paint all exposed surfaces
CLEARCOAT: UV Anti/Graffiti
FASTENER: Mechanically fastened to Strap

27. POLE

POLE: 3 1/2" dia. 1/4" thick aluminum

MATERIAL: Aluminum
FABRICATION PROCESS: Extruded
EDGES: Smooth
COLOR: custom as noted
SURFACE PROCESS: Paint all exposed surfaces
CLEARCOAT: UV Anti/Graffiti
FOOTER: As per NCDOT Division 9 Breakaway specifications

28. ACCENT BAR

MATERIAL: 1/4" thick Aluminum bar stock FABRICATION PROCESS: Extruded / Cut EDGES: Square COLOR: custom, as noted SURFACE PROCESS: Paint all exposed surfaces CLEARCOAT: UV Anti/Graffiti FASTENER: mechanically fasten to sign panel

29. PEDESTRIAN POLE CAP

PRODUCT: Cast Aluminum Post Top Finial MATERIAL: Aluminum FABRICATION PROCESS: Cast EDGES: Smooth
COLOR: custom as noted
SURFACE PROCESS: Paint all exposed surfaces
CLEARCOAT: UV Anti/Graffiti

FUNCTION: Pedestrian Directional

30. BREAKAWAY FOOTERProduct: TRANSPO Breakaway sign support system or NCDOT

Approved equal Type: Male/Female Coupling assembly. Base Plate welded to pole. Size and specs to be determined by Contractors structural engineer.

NOTE: All signs are positioned within NCDOT R.O.W. and shall be breakaway as per NCDOT Division 9 Breakaway specifica-

DESIGN NOTE:

Final design and shop drawings shall be supplied by the fabricator. North Carolina registered professional engineer is required to sign and seal the submittal of shop drawings.

OTES


y legal department.

- Fabricator shall verify the mounting conditions and provide a detail drawing for each mounting situation, prior to fabrication.
 Fabricator shall obtain approval from the Designer or Client for placement prior to fabrication.
- 2. Welds: All welds shall be ground smooth, paint all seams.
- 3. Hardware: All fasteners shall be concealed. If exposed, hardware shall be tamper proof fasteners, corrosion resistant, and color matching adjacent surfaces.
- 4. All painted sign surfaces to receive UV/Anti-Graffiti spray coating. All sign surfaces with reflective graphics to recieve 3M

CLIENT / PROJECT ENVIRONMENTS & EXPERIENCES Clty of Greenville, NC 120 North Church Street City of Greenville, NC Suite 208 **Wayfinding and Signage** West Chester, PA 19380 T 484.266.0648 www.merjedesign.com PROJECT NO. Y41-07963 SUBCONSULTANT SHEET TITLE DRAWN BY: 6/30/2009 KB/GS Sign Type PED.1B These drawings are meant for DESIGN INTENT ONLY REVISIONS **Pedestrian Directional** and are not for construction. Contractor shall verify and be responsible for all dimensions and condition of the job. Contractor shall be familiar with the site 05/22/2010 and conditions it presents. This office must be noti-SHEET NO. fied of any variations from the dimensions and cond 08/06/2010 tions shown on this drawing. Shop drawings and details must be submitted to this office for approval **D.21** prior to proceeding with fabrication. All copy shall be 09/01/2010 proofread by client and legal requirements checked


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North Wales, PA 19454

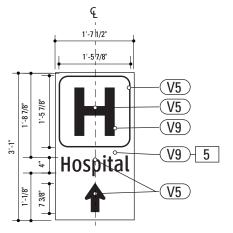

Alternate Graphic Layout: SERVICE.1 SCALE: 1/2" = 1'-0"

SCALE: 1/2" = 1'-0"

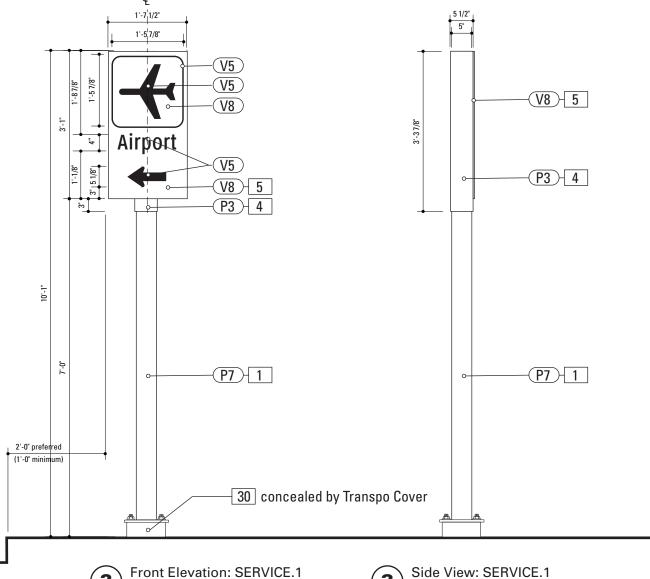

Side View: SERVICE.1 SCALE: 1/2" = 1'-0"

SPECIFICATIONS

SIGN TYPE: SERVICE.1 FUNCTION: Service Trailblazer

POLE: 5" dia. 1/4" thick aluminum MATERIAL: Aluminum FABRICATION PROCESS: Extruded EDGES: Smooth COLOR: custom as noted SURFACE PROCESS: Paint all exposed surfaces CLEARCOAT: UV Anti/Graffiti

FOOTER: As per NCDOT Division 9 Breakaway specifications

The Pole should be fully fabricated/finished with mounting plate for future field replacement. Bench Stock pole length would match the tallest sign type and trimmed to size as replacements are needed.

4. SLEEVE

MATERIAL: 1/4" thk Aluminum FABRICATION PROCESS: Extruded FDGFS: Square COLOR: custom, as noted SURFACE PROCESS: Paint all exposed surfaces CLEARCOAT: UV Anti/Graffiti FASTENER: Mechanically fastened to pole

5. SIGN PANEL - REFLECTIVE VINYL

MATERIAL: 1/4" thk Aluminu FABRICATION PROCESS: Router Cut EDGES: Smooth COLOR: Custom, as noted GRAPHIC BACKGROUND AND COPY PROCESS: 3M custom screened inks print direct to 3930 with 3M approved UV/ Graffiti Vinyl Over-laminates. (See Color Sheet A6 for all color and material specifications) FASTENER: Mechanical Reflective Vinyl Graphics applied to front face of Sign Panel. See Color Page for Specifications.

30. BREAKAWAY FOOTER

Product: TRANSPO Breakaway sign support system or NCDOT Approved equal Type: Male/Female Coupling assembly. Base Plate welded to pole. Size and specs to be determined by Contractors structural

NOTE: All signs are positioned within NCDOT R.O.W. and shall be breakaway as per NCDOT Division 9 Breakaway specifica-

DESIGN NOTE:

Final design and shop drawings shall be supplied by the fabricator. North Carolina registered professional engineer is required to sign and seal the submittal of shop drawings.


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- 1. Fabricator shall verify the mounting conditions and provide a detail drawing for each mounting situation, prior to fabrication. Fabricator shall obtain approval from the Designer or Client for placement prior to fabrication.
- 2. Welds: All welds shall be ground smooth, paint all seams.
- 3. Hardware: All fasteners shall be concealed. If exposed, hardware shall be tamper proof fasteners, corrosion resistant, and color matching adjacent surfaces.
- 4. All painted sign surfaces to receive UV/Anti-Graffiti spray coating. All sign surfaces with reflective graphics to recieve 3M

CLIENT / PROJECT ENVIRONMENTS & EXPERIENCES Clty of Greenville, NC 120 North Church Street City of Greenville, NC Suite 208 **Wayfinding and Signage** West Chester, PA 19380 T 484.266.0648 www.merjedesign.com PROJECT NO. Y41-07963 SUBCONSULTANT SHEET TITLE DRAWN BY: 6/30/2009 KB/GS Sign Type SERVICE.1 These drawings are meant for DESIGN INTENT ONLY REVISIONS **Service Trailblazer** and are not for construction. Contractor shall verify and be responsible for all dimensions and condition of the job. Contractor shall be familiar with the site 05/22/2010 and conditions it presents. This office must be noti-SHEET NO. fied of any variations from the dimensions and cond 08/06/2010 tions shown on this drawing. Shop drawings and details must be submitted to this office for approval **D.22** prior to proceeding with fabrication. All copy shall be 09/01/2010 proofread by client and legal requirements checked

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SPECIFICATIONS

SIGN TYPE: SERVICE.2 FUNCTION: Service Trailblazer

POLE: 5" dia. 1/4" thick aluminum MATERIAL: Aluminum FABRICATION PROCESS: Extruded EDGES: Smooth COLOR: custom as noted SURFACE PROCESS: Paint all exposed surfaces

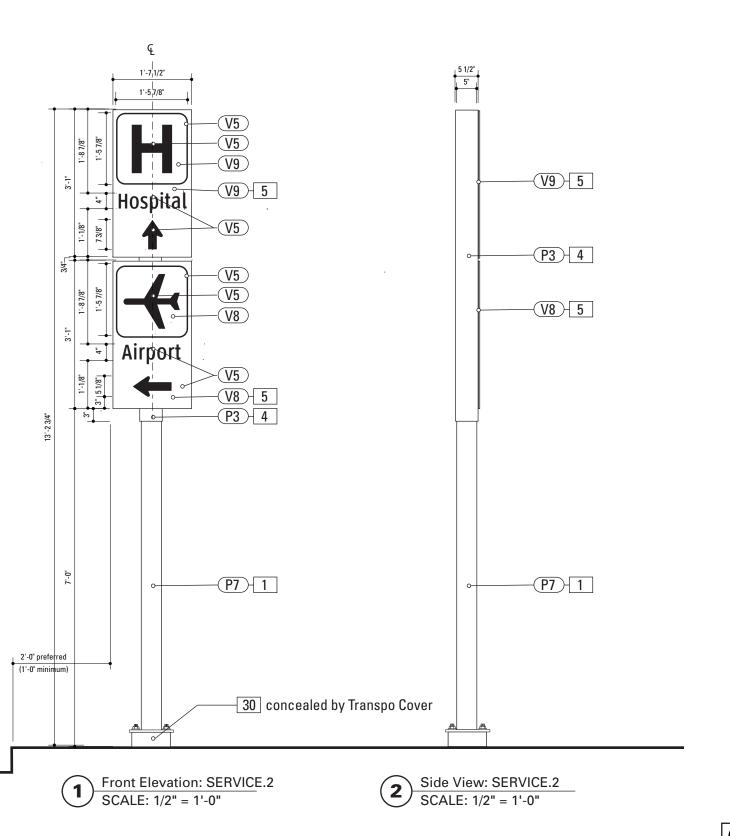CLEARCOAT: UV Anti/Graffiti FOOTER: As per NCDOT Division 9 Breakaway specifications

The Pole should be fully fabricated/finished with mounting plate for future field replacement. Bench Stock pole length would match the tallest sign type and trimmed to size as replacements are needed.

4. SLEEVE

MATERIAL: 1/4" thk Aluminum FABRICATION PROCESS: Extruded FDGFS: Square COLOR: custom, as noted SURFACE PROCESS: Paint all exposed surfaces CLEARCOAT: UV Anti/Graffiti FASTENER: Mechanically fastened to pole

5. SIGN PANEL - REFLECTIVE VINYL

MATERIAL: 1/4" thk Aluminun FABRICATION PROCESS: Router Cut EDGES: Smooth COLOR: Custom, as noted GRAPHIC BACKGROUND AND COPY PROCESS: 3M custom screened inks print direct to 3930 with 3M approved UV/ Graffiti Vinyl Over-laminates. (See Color Sheet A6 for all color and material specifications) FASTENER: Mechanical Reflective Vinyl Graphics applied to front face of Sign Panel. See Color Page for Specifications.

30. BREAKAWAY FOOTER

Product: TRANSPO Breakaway sign support system or NCDOT Approved equal Type: Male/Female Coupling assembly. Base Plate welded to pole. Size and specs to be determined by Contractors structural

NOTE: All signs are positioned within NCDOT R.O.W. and shall be breakaway as per NCDOT Division 9 Breakaway specifica-

DESIGN NOTE:

Final design and shop drawings shall be supplied by the fabricator. North Carolina registered professional engineer is required to sign and seal the submittal of shop drawings.


y legal department.

- 1. Fabricator shall verify the mounting conditions and provide a detail drawing for each mounting situation, prior to fabrication. Fabricator shall obtain approval from the Designer or Client for placement prior to fabrication.
- 2. Welds: All welds shall be ground smooth, paint all seams.
- 3. Hardware: All fasteners shall be concealed. If exposed, hardware shall be tamper proof fasteners, corrosion resistant, and color matching adjacent surfaces.
- 4. All painted sign surfaces to receive UV/Anti-Graffiti spray coating. All sign surfaces with reflective graphics to recieve 3M

CLIENT / PROJECT ENVIRONMENTS & EXPERIENCES Clty of Greenville, NC 120 North Church Street City of Greenville, NC Suite 208 **Wayfinding and Signage** West Chester, PA 19380 T 484.266.0648 www.merjedesign.com PROJECT NO. Y41-07963 SUBCONSULTANT SHEET TITLE DRAWN BY: 6/30/2009 KB/GS Sign Type SERVICE.2 These drawings are meant for DESIGN INTENT ONLY REVISIONS **Service Trailblazer** and are not for construction. Contractor shall verify and be responsible for all dimensions and condition of the job. Contractor shall be familiar with the site 05/22/2010 and conditions it presents. This office must be noti-SHEET NO. fied of any variations from the dimensions and condi 08/06/2010 tions shown on this drawing. Shop drawings and details must be submitted to this office for approval **D.23** prior to proceeding with fabrication. All copy shall be 09/01/2010 proofread by client and legal requirements checked

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Gary K. Munkelt & Associates Structural Consulting Engineers 1180 Welsh Rd, Suite 190 North Wales, PA 19454

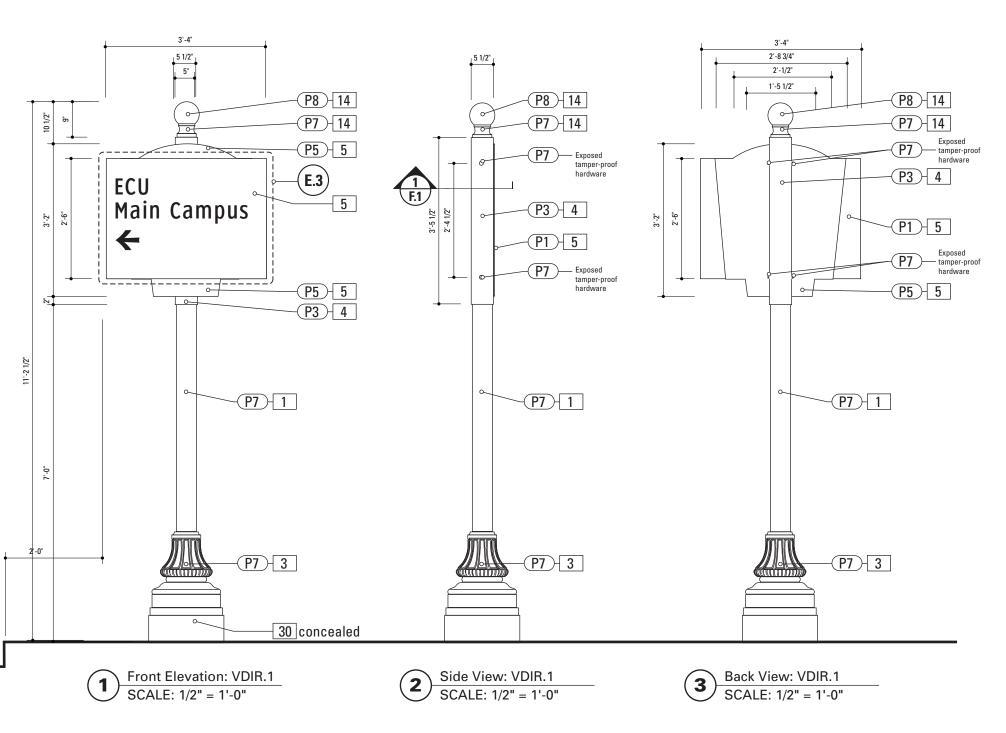

SPECIFICATIONS SIGN TYPE: VDIR.1 **FUNCTION:** Vehicular Directional

POLE: 5" Nominal dia. OD. 5.563 Schedule 40 Wall Thickness 0.258 ID 5.047 MATERIAL · Aluminum

FABRICATION PROCESS: Extruded EDGES: Smooth COLOR: custom as noted

SURFACE PROCESS: Powdercoated - Finish: Factory Finish from Pole/Base Manufacturer.

CLEARCOAT: UV Anti/Graffiti FOOTER: As per NCDOT Division 9 Breakaway specifications

The Pole should be fully fabricated/finished with mounting plate for future field replacement. Bench Stock pole length would match the tallest sign type and trimmed to size as replacements are needed.

3. DECORATIVE BASE

CAST: Wrap around 2 piece base. Mechanically tightened. MATERIAL: Aluminum EDGES: Smooth

COLOR: Custom, as noted

SURFACE PROCESS: Powdercoated - Finish: Factory Finish from Pole/Base Manufacturer.

CL FARCOAT: LIV Anti/Graffiti STYLE: HADCO WAB 3000 Series or HAPCO Brand ARLEN, or

approved equal. FASTENER: Mechanically tightened around pole Contractor to provide rubber gaskets were base and pole meet for tight fit. NOTE: A level concrete pad is to be formed to anchor the

base, flush to grade.

4. SLEEVE

MATERIAL: 1/4" thk Aluminum FABRICATION PROCESS: Extruded EDGES: Square COLOR: custom, as noted SURFACE PROCESS: Paint all exposed surfaces CLEARCOAT: UV Anti/Graffiti FASTENER: Mechanically fastened to pole

5. SIGN PANEL - REFLECTIVE VINYL MATERIAL: 1/4" thk Aluminum FABRICATION PROCESS: Router Cut EDGES: Smooth COLOR: Custom, as noted GRAPHIC BACKGROUND AND COPY PROCESS: 3M custom screened inks print direct to 3930 with 3M approved UV/ Graffiti Vinvl Over-laminates, (See Color Sheet A6 for all color and material specifications) FASTENER: Mechanical

Reflective Vinyl Graphics applied to front face of Sign Panel. See Color Page for Specifications.

14. POLE CAP

PRODUCT: Cast Aluminum Post Ton Finial MATERIAL: Aluminum FABRICATION PROCESS: Cast EDGES: Smooth COLOR: custom as noted SURFACE Process: Paint all exposed surfaces CLEARCOAT: UV Anti/Graffiti FASTENER: Mechanically fasten to pole

30. BREAKAWAY FOOTER

Product: TRANSPO Breakaway sign support system or NCDOT Approved equal

Type: Male/Female Coupling assembly. Base Plate welded to pole.

Size and specs to be determined by Contractors structural

NOTE: All signs are positioned within NCDOT R.O.W. and shall be breakaway as per NCDOT Division 9 Breakaway specifica-

Seperate Spun Metal Base Cover hides couplings.

Finish: Factory Finish from Pole/Base Manufacturer.

A seperate Spun Metal Base Cover hides couplings and is coordinated to fit around the Cast Metal Base to accommodate the Transpo Footer. (as shown in Bid Document Drawings.)

Providers of decorative bases (such as Hadco or Hanco) provide the sized pole that matches the opening of the Base. Shop Drawings from the pole/base provider are required for review and approval.

The design style suggested by the Contractor is subject to Designer/Owner review and approval. Finish: Factory Finish from Pole/Base Manufacturer.

DESIGN NOTE:

Final design and shop drawings shall be supplied by the fabricator. North Carolina registered professional engineer is required to sign and seal the submittal of shop drawings.


y legal department.

- 1. Fabricator shall verify the mounting conditions and provide a detail drawing for each mounting situation, prior to fabrication. Fabricator shall obtain approval from the Designer or Client for placement prior to fabrication.
- 2. Welds: All welds shall be ground smooth, paint all seams.
- 3. Hardware: All fasteners shall be concealed. If exposed, hardware shall be tamper proof fasteners, corrosion resistant, and color matching adjacent surfaces.
- 4. All painted sign surfaces to receive UV/Anti-Graffiti spray coating. All sign surfaces with reflective graphics to recieve 3M



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SPECIFICATIONS SIGN TYPE: VDIR.1B

POLE: 5" dia. 1/4" thick aluminum MATERIAL: Aluminum FABRICATION PROCESS: Extruded

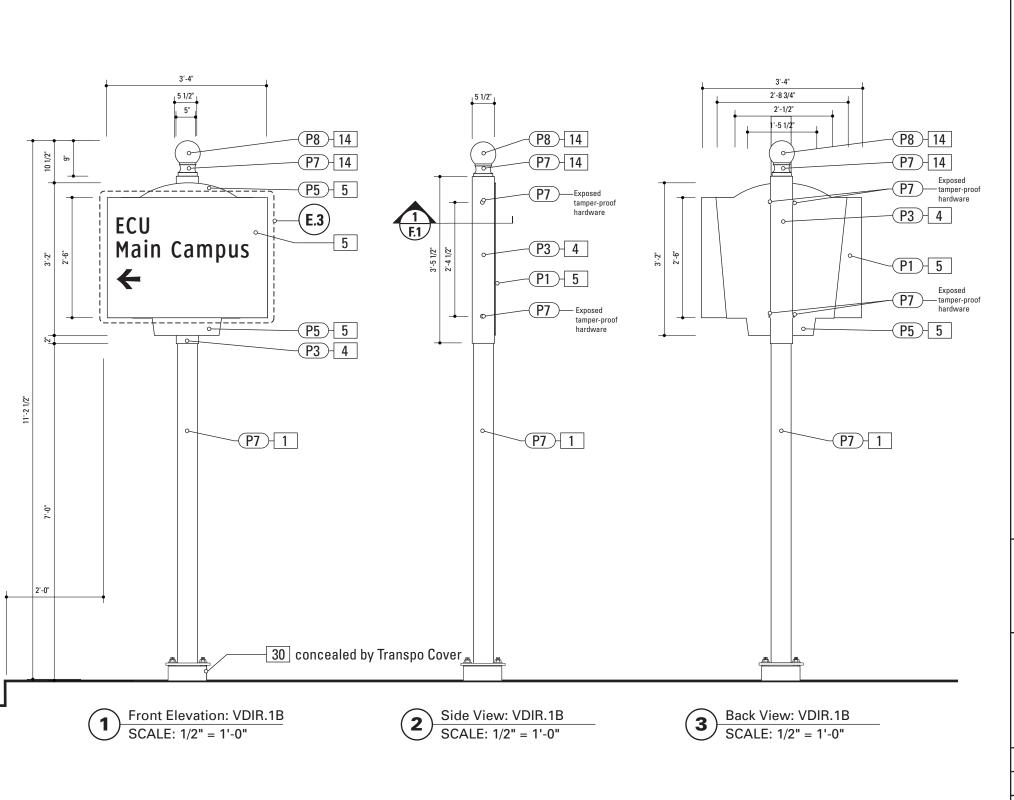EDGES: Smooth COLOR: custom as noted SURFACE PROCESS: Paint all exposed surfaces

CLEARCOAT: UV Anti/Graffiti FOOTER: As per NCDOT Division 9 Breakaway specifications

The Pole should be fully fabricated/finished with mounting plate for future field replacement. Bench Stock pole length would match the tallest sign type and trimmed to size as replacements are needed.

4. SLEEVE

MATERIAL: 1/4" thk Aluminum FABRICATION PROCESS: Extruded EDGES: Square COLOR: custom, as noted SURFACE PROCESS: Paint all exposed surfaces CLEARCOAT: UV Anti/Graffiti FASTENER: Mechanically fastened to pole

SIGN PANEL - REFLECTIVE VINYL

MATERIAL: 1/4" thk Aluminun FABRICATION PROCESS: Router Cut FDGFS: Smooth

COLOR: Custom, as noted GRAPHIC BACKGROUND AND COPY PROCESS: 3M custom screened inks print direct to 3930 with 3M approved UV/ Graffiti Vinyl Over-laminates. (See Color Sheet A6 for all color and material specifications)

FASTENER: Mechanical Reflective Vinyl Graphics applied to front face of Sign Panel. See Color Page for Specifications.

14. POLE CAP

PRODUCT: Cast Aluminum Post Top Finial MATERIAL: Aluminum FABRICATION PROCESS: Cast EDGES: Smooth COLOR: custom as noted SURFACE Process: Paint all exposed surfaces CLEARCOAT: Acrylic Polyurethane Clear Satin FASTENER: Mechanically fasten to pole

30. BREAKAWAY FOOTER

Product: TRANSPO Breakaway sign support system or NCDOT Approved equal

Type: Male/Female Coupling assembly.

proofread by client and legal requirements checked

y legal department.

Base Plate welded to pole. Size and specs to be determined by Contractors structural

NOTE: All signs are positioned within NCDOT R.O.W. and shall be breakaway as per NCDOT Division 9 Breakaway specifica-

DESIGN NOTE:

FUNCTION: Vehicular Directional

Final design and shop drawings shall be supplied by the fabricator. North Carolina registered professional engineer is required to sign and seal the submittal of shop drawings.


D.25

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CLIENT / PROJECT ENVIRONMENTS & EXPERIENCES Clty of Greenville, NC 120 North Church Street City of Greenville, NC Suite 208 **Wayfinding and Signage** West Chester, PA 19380 T 484.266.0648 www.merjedesign.com PROJECT NO. Y41-07963 SUBCONSULTANT SHEET TITLE DRAWN BY: 6/30/2009 KB/GS Sign Type VDIR.1B These drawings are meant for DESIGN INTENT ONLY REVISIONS **Vehicular Directional** and are not for construction. Contractor shall verify and be responsible for all dimensions and condition of the job. Contractor shall be familiar with the site 05/22/2010 and conditions it presents. This office must be noti-SHEET NO. fied of any variations from the dimensions and cond 08/06/2010 tions shown on this drawing. Shop drawings and details must be submitted to this office for approval prior to proceeding with fabrication. All copy shall be 09/01/2010

01/31/2011

Gary K. Munkelt & Associates Structural Consulting Engineers 1180 Welsh Rd, Suite 190 North Wales, PA 19454

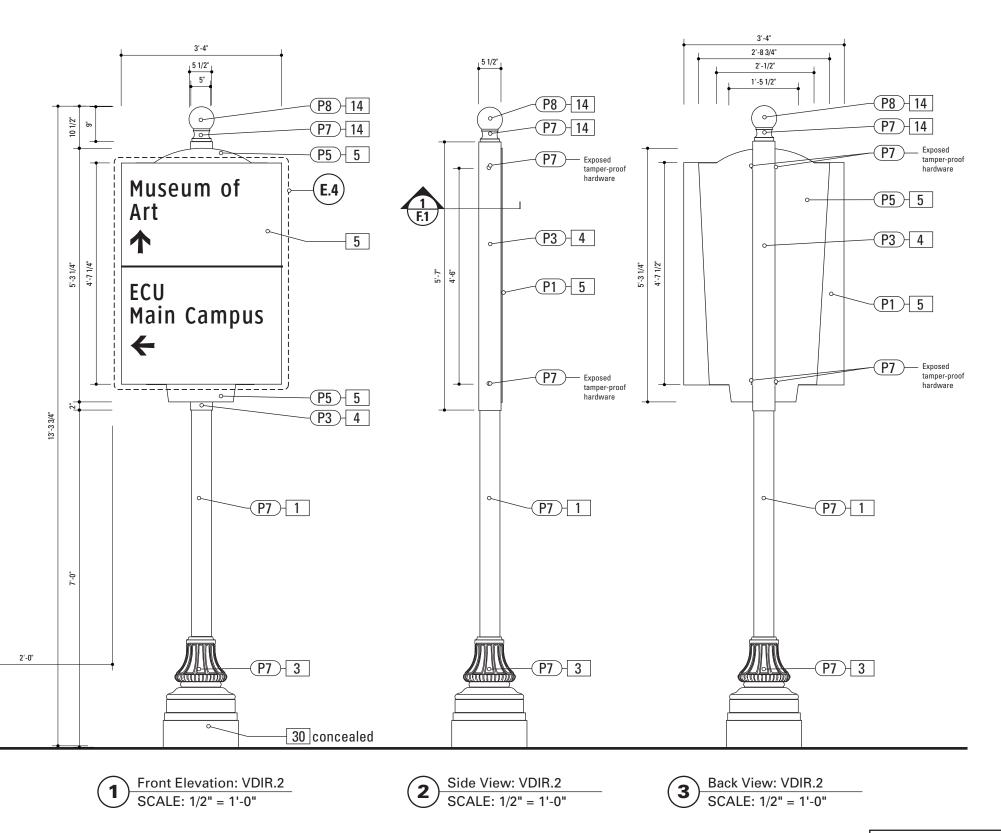

SPECIFICATIONS SIGN TYPE: VDIR.2 FUNCTION: Vehicular Directional

1. POI

POLE: 5" Nominal dia. OD. 5.563 Schedule 40 Wall Thickness 0.258 ID 5.047

MATERIAL: Aluminum FABRICATION PROCESS: Extruded

FABRICATION PROCESS: Extruded EDGES: Smooth COLOR: custom as noted

from Pole/Base Manufacturer.

CLEARCOAT: UV Anti/Graffiti

FOOTER: As per NCDOT Division 9 Breakaway specifications

SURFACE PROCESS: Powdercoated - Finish: Factory Finish

No

The Pole should be fully fabricated/finished with mounting plate for future field replacement. Bench Stock pole length would match the tallest sign type and trimmed to size as replacements are needed.

3. DECORATIVE BASE

CAST: Wrap around 2 piece base. Mechanically tightened.

MATERIAL: Aluminum EDGES: Smooth

COLOR: Custom, as noted

SURFACE PROCESS: Powdercoated - Finish: Factory Finish from Pole/Base Manufacturer.

CLEARCOAT: UV Anti/Graffiti

STYLE: HADCO WAB 3000 Series or HAPCO Brand ARLEN. or approved equal.

FÄSTENER: Mechanically tightened around pole Contractor to provide rubber gaskets were base and pole meet for tight fit. NOTE: A level concrete pad is to be formed to anchor the base, flush to grade.

4. SLEEVE

MATERIAL: 1/4" thk Aluminum FABRICATION PROCESS: Extruded EDGES: Square

COLOR: custom, as noted
SURFACE PROCESS: Paint all exposed surfaces

CLEARCOAT: UV Anti/Graffiti
FASTENER: Mechanically fastened to pole

5. SIGN PANEL - REFLECTIVE VINYL MATERIAL: 1/4" thk Aluminum

FABRICATION PROCESS: Router Cut EDGES: Smooth

COLOR: Custom, as noted

GRAPHIC BACKGROUND AND COPY PROCESS: 3M custom screened inks print direct to 3930 with 3M approved UV/ Graffiti Vinyl Over-laminates. (See Color Sheet A6 for all color and material specifications)

FASTENER: Mechanical

Reflective Vinyl Graphics applied to front face of Sign Panel. See Color Page for Specifications.

14. POLE CAP

PRODUCT: Cast Aluminum Post Top Finial MATERIAL: Aluminum FABRICATION PROCESS: Cast EDGES: Smooth COLOR: custom as noted SURFACE Process: Paint all exposed surfaces CLEARCOAT: UV Anti/Graffiti FASTENER: Mechanically fasten to pole

30. BREAKAWAY FOOTER

Product: TRANSPO Breakaway sign support system or NCDOT Approved equal

Type: Male/Female Coupling assembly.

Base Plate welded to pole.

Size and specs to be determined by Contractors structural

NOTE: All signs are positioned within NCDOT R.O.W. and shall be breakaway as per NCDOT Division 9 Breakaway specifications.

Seperate Spun Metal Base Cover hides couplings.

Finish: Factory Finish from Pole/Base Manufacturer.

IOTE:

A seperate Spun Metal Base Cover hides couplings and is coordinated to fit around the Cast Metal Base to accommodate the Transpo Footer. (as shown in Bid Document Drawings.)

Providers of decorative bases (such as Hadco or Hapco) provide the sized pole that matches the opening of the Base. Shop Drawings from the pole/base provider are required for review and approval.

The design style suggested by the Contractor is subject to Designer/Owner review and approval. Finish: Factory Finish from Pole/Base Manufacturer.

DESIGN NOTE:


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OTES

- Fabricator shall verify the mounting conditions and provide a detail drawing for each mounting situation, prior to fabrication.
 Fabricator shall obtain approval from the Designer or Client for placement prior to fabrication.
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- 3. Hardware: All fasteners shall be concealed. If exposed, hardware shall be tamper proof fasteners, corrosion resistant, and color matching adjacent surfaces.
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1180 Welsh Rd, Suite 190
North Wales, PA 19454



SPECIFICATIONS SIGN TYPE: VDIR.2B FUNCTION: Vehicular Directional

POLE: 5" dia. 1/4" thick aluminum MATERIAL: Aluminum FABRICATION PROCESS: Extruded EDGES: Smooth COLOR: custom as noted SURFACE PROCESS: Paint all exposed surfaces CLEARCOAT: UV Anti/Graffiti

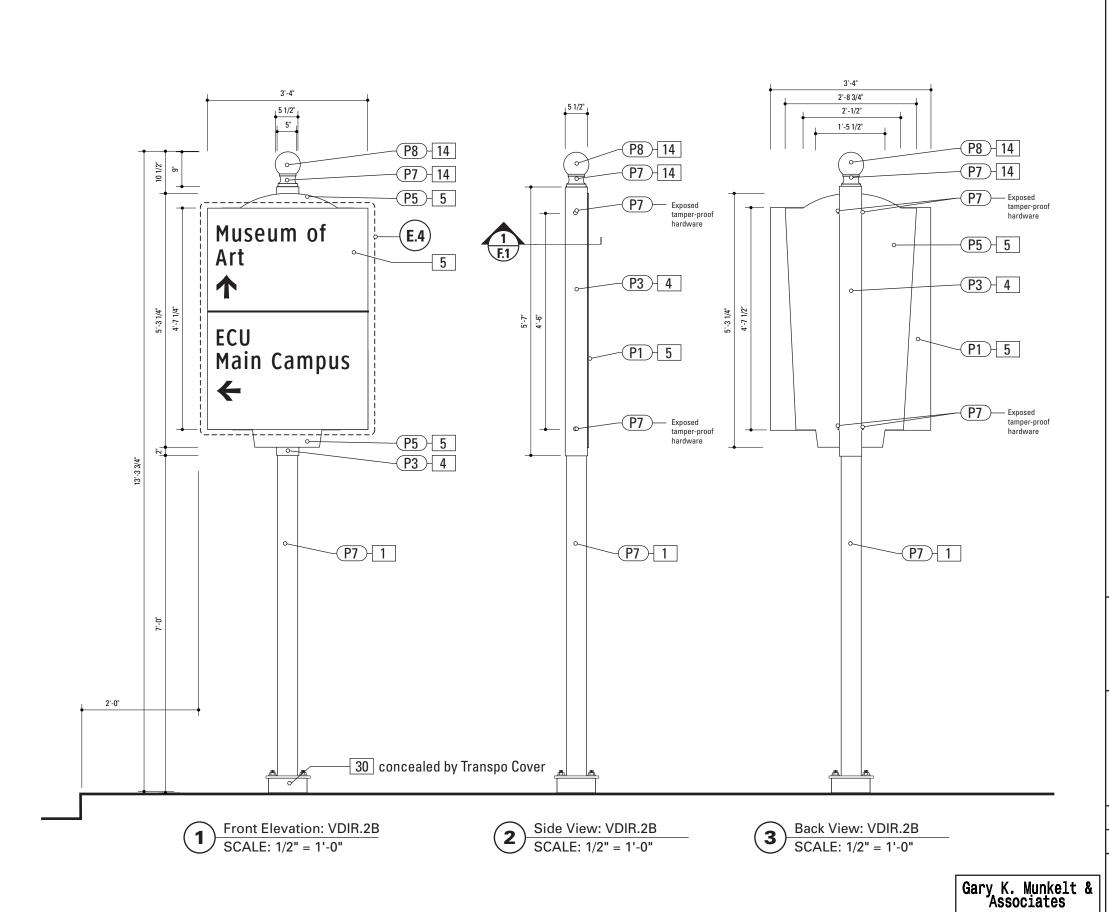FOOTER: As per NCDOT Division 9 Breakaway specifications

The Pole should be fully fabricated/finished with mounting plate for future field replacement. Bench Stock pole length would match the tallest sign type and trimmed to size as replacements are needed.

4. SLEEVE

MATERIAL: 1/4" thk Aluminum FABRICATION PROCESS: Extruded FDGFS: Square COLOR: custom, as noted SURFACE PROCESS: Paint all exposed surfaces CLEARCOAT: UV Anti/Graffiti FASTENER: Mechanically fastened to pole

5. SIGN PANEL - REFLECTIVE VINYL

MATERIAL · 1/4" thk Aluminun FABRICATION PROCESS: Router Cut EDGES: Smooth COLOR: Custom, as noted GRAPHIC BACKGROUND AND COPY PROCESS: 3M custom screened inks print direct to 3930 with 3M approved UV/ Graffiti Vinyl Over-laminates. (See Color Sheet A6 for all color and material specifications) FASTENER: Mechanical Reflective Vinyl Graphics applied to front face of Sign Panel. See Color Page for Specifications.

14. POLE CAP

PRODUCT: Cast Aluminum Post Top Finial MATERIAL: Aluminum FABRICATION PROCESS: Cast EDGES: Smooth COLOR: custom as noted SURFACE Process: Paint all exposed surfaces CLEARCOAT: Acrylic Polyurethane Clear Satin FASTENER: Mechanically fasten to pole

30. BREAKAWAY FOOTER

Product: TRANSPO Breakaway sign support system or NCDOT Approved equal Type: Male/Female Coupling assembly. Base Plate welded to pole. Size and specs to be determined by Contractors structural

NOTE: All signs are positioned within NCDOT R.O.W. and shall

DESIGN NOTE:


be breakaway as per NCDOT Division 9 Breakaway specifica-

Final design and shop drawings shall be supplied by the fabricator. North Carolina registered professional engineer is required to sign and seal the submittal of shop drawings.

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- 3. Hardware: All fasteners shall be concealed. If exposed, hardware shall be tamper proof fasteners, corrosion resistant, and color matching adjacent surfaces.
- 4. All painted sign surfaces to receive UV/Anti-Graffiti spray coating. All sign surfaces with reflective graphics to recieve 3M



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SPECIFICATIONS SIGN TYPE: VDIR.3 FUNCTION: Vehicular Directional

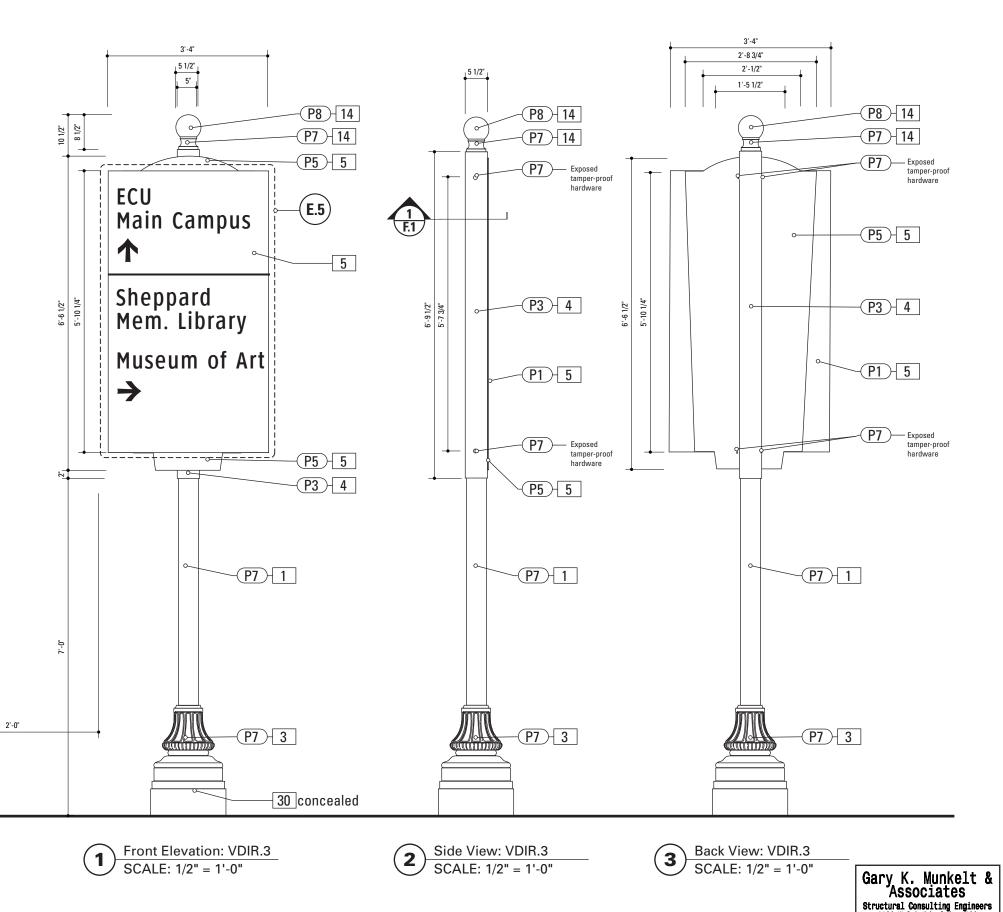POLE: 5" Nominal dia. OD. 5.563 Schedule 40 Wall Thickness 0.258 ID 5.047 MATERIAL: Aluminum

FABRICATION PROCESS: Extruded EDGES: Smooth

COLOR: custom as noted SURFACE PROCESS: Powdercoated - Finish: Factory Finish from Pole/Base Manufacturer.

CLEARCOAT: UV Anti/Graffiti FOOTER: As per NCDOT Division 9 Breakaway specifications

The Pole should be fully fabricated/finished with mounting plate for future field replacement. Bench Stock pole length would match the tallest sign type and trimmed to size as replacements are needed.

3. DECORATIVE BASE

CAST: Wrap around 2 piece base. Mechanically tightened. MATERIAL: Aluminum

EDGES: Smooth

COLOR: Custom, as noted

SURFACE PROCESS: Powdercoated - Finish: Factory Finish from Pole/Base Manufacturer.

CL FARCOAT: LIV Anti/Graffiti

STYLE: HADCO WAB 3000 Series or HAPCO Brand ARLEN, or

approved equal. FASTENER: Mechanically tightened around pole Contractor to provide rubber gaskets were base and pole meet for tight fit. NOTE: A level concrete pad is to be formed to anchor the

base, flush to grade.

4. SLEEVE
MATERIAL: 1/4" thk Aluminum FABRICATION PROCESS: Extruded EDGES: Square COLOR: custom, as noted

SURFACE PROCESS: Paint all exposed surfaces CLEARCOAT: UV Anti/Graffiti FASTENER: Mechanically fastened to pole

5. SIGN PANEL - REFLECTIVE VINYL MATERIAL: 1/4" thk Aluminum FABRICATION PROCESS: Router Cut

EDGES: Smooth

COLOR: Custom, as noted

GRAPHIC BACKGROUND AND COPY PROCESS: 3M custom screened inks print direct to 3930 with 3M approved UV/ Graffiti Vinvl Over-laminates. (See Color Sheet A6 for all color and material specifications) FASTENER: Mechanical

Reflective Vinyl Graphics applied to front face of Sign Panel. See Color Page for Specifications.

14. POLE CAP

PRODUCT: Cast Aluminum Post Top Finial MATERIAL: Aluminum FABRICATION PROCESS: Cast EDGES: Smooth COLOR: custom as noted SURFACE Process: Paint all exposed surfaces CLEARCOAT: UV Anti/Graffiti FASTENER: Mechanically fasten to pole

30. BREAKAWAY FOOTER

Product: TRANSPO Breakaway sign support system or NCDOT Approved equal

Type: Male/Female Coupling assembly.

Base Plate welded to pole.

Size and specs to be determined by Contractors structural

NOTE: All signs are positioned within NCDOT R.O.W. and shall be breakaway as per NCDOT Division 9 Breakaway specifica-

Seperate Spun Metal Base Cover hides couplings.

Finish: Factory Finish from Pole/Base Manufacturer.

A seperate Spun Metal Base Cover hides couplings and is coordinated to fit around the Cast Metal Base to accommodate the Transpo Footer. (as shown in Bid Document Drawings.)

Providers of decorative bases (such as Hadco or Hanco) provide the sized pole that matches the opening of the Base. Shop Drawings from the pole/base provider are required for review and approval.

The design style suggested by the Contractor is subject to Designer/Owner review and approval. Finish: Factory Finish from Pole/Base Manufacturer.


DESIGN NOTE:

Final design and shop drawings shall be supplied by the fabricator. North Carolina registered professional engineer is required to sign and seal the submittal of shop drawings.

- 1. Fabricator shall verify the mounting conditions and provide a detail drawing for each mounting situation, prior to fabrication. Fabricator shall obtain approval from the Designer or Client for placement prior to fabrication.
- 2. Welds: All welds shall be ground smooth, paint all seams.
- 3. Hardware: All fasteners shall be concealed. If exposed, hardware shall be tamper proof fasteners, corrosion resistant, and color matching adjacent surfaces.
- 4. All painted sign surfaces to receive UV/Anti-Graffiti spray coating. All sign surfaces with reflective graphics to recieve 3M



Structural Consulting Engineers 1180 Welsh Rd, Suite 190 North Wales, PA 19454

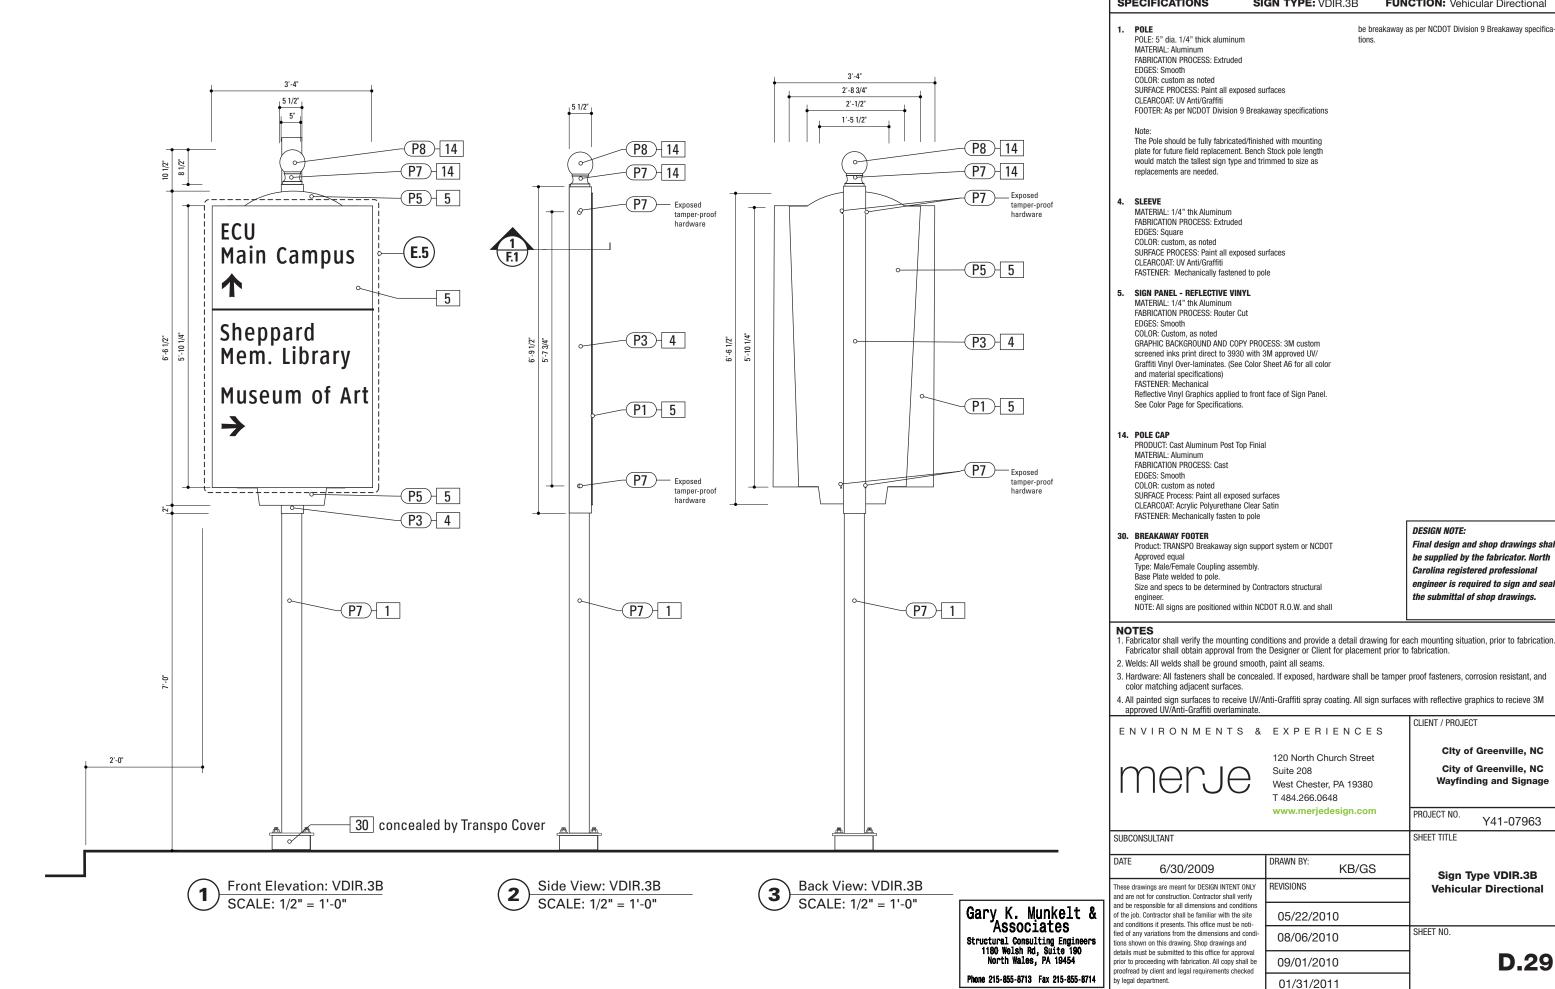


SPECIFICATIONS SIGN TYPE: VDIR.3B FUNCTION: Vehicular Directional

DESIGN NOTE:

Final design and shop drawings shall be supplied by the fabricator. North Carolina registered professional engineer is required to sign and seal the submittal of shop drawings.

- 1. Fabricator shall verify the mounting conditions and provide a detail drawing for each mounting situation, prior to fabrication. Fabricator shall obtain approval from the Designer or Client for placement prior to fabrication.
- 3. Hardware: All fasteners shall be concealed. If exposed, hardware shall be tamper proof fasteners, corrosion resistant, and
- 4. All painted sign surfaces to receive UV/Anti-Graffiti spray coating. All sign surfaces with reflective graphics to recieve 3M

CLIENT / PROJECT Clty of Greenville, NC City of Greenville, NC **Wayfinding and Signage** PROJECT NO. Y41-07963 SHEET TITLE Sign Type VDIR.3B **Vehicular Directional** SHEET NO. **D.29**

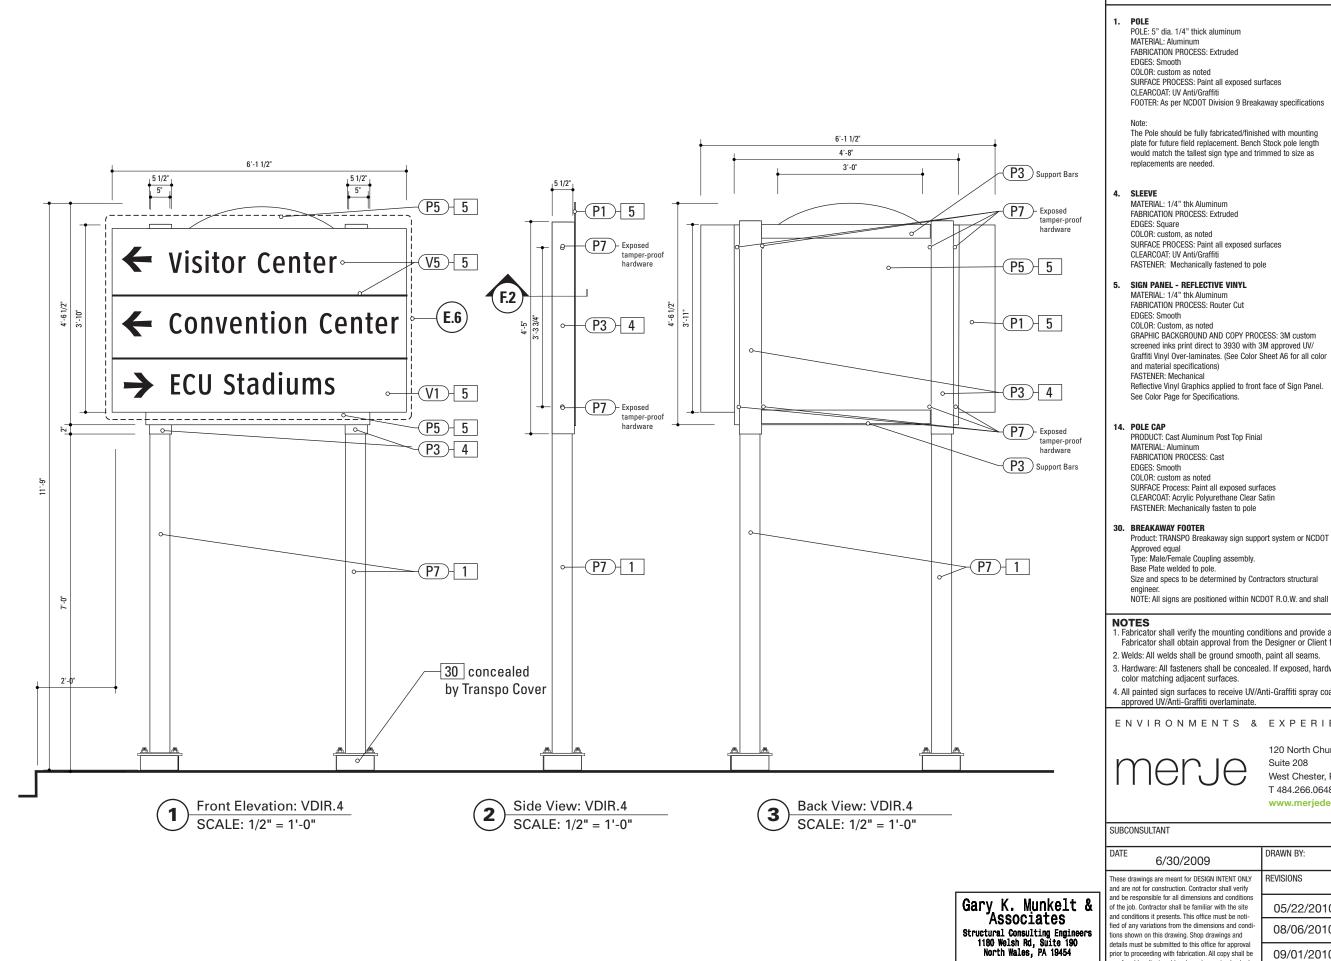

SPECIFICATIONS SIGN TYPE: VDIR.4 **FUNCTION:** Vehicular Directional

FOOTER: As per NCDOT Division 9 Breakaway specifications

plate for future field replacement. Bench Stock pole length would match the tallest sign type and trimmed to size as

GRAPHIC BACKGROUND AND COPY PROCESS: 3M custom screened inks print direct to 3930 with 3M approved UV/ Graffiti Vinyl Over-laminates. (See Color Sheet A6 for all color Reflective Vinyl Graphics applied to front face of Sign Panel.

DESIGN NOTE:

be breakaway as per NCDOT Division 9 Breakaway specifica-


Final design and shop drawings shall be supplied by the fabricator. North Carolina registered professional engineer is required to sign and seal the submittal of shop drawings.


- 1. Fabricator shall verify the mounting conditions and provide a detail drawing for each mounting situation, prior to fabrication. Fabricator shall obtain approval from the Designer or Client for placement prior to fabrication.

- 3. Hardware: All fasteners shall be concealed. If exposed, hardware shall be tamper proof fasteners, corrosion resistant, and
- 4. All painted sign surfaces to receive UV/Anti-Graffiti spray coating. All sign surfaces with reflective graphics to recieve 3M



E. Graphic Layouts

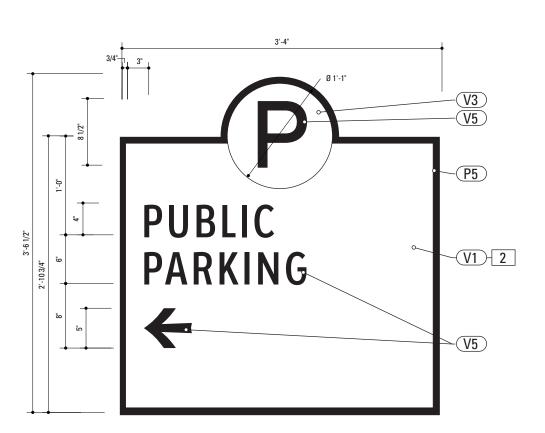

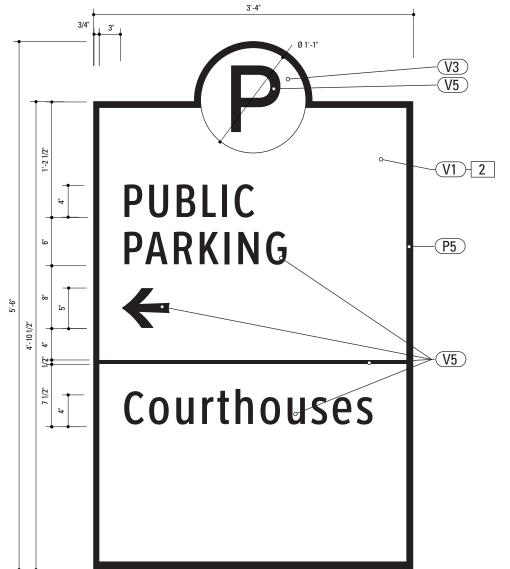

Graphic Layout: PARK.3 SCALE: 1" = 1'-0"

Graphic Layout: PARK.4 SCALE: 1" = 1'-0"

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Structural Consulting Engineers
1180 Welsh Rd, Suite 190
North Wales, PA 19454

Phone 215-855-8713 Fax 215-855-8714

SPECIFICATIONS SIGN TYPE: PARK.3-4

FUNCTION: Parking Directional

2. SIGN PANEL - REFLECTIVE VINYL

MATERIAL: 1/4" thk Aluminum FABRICATION PROCESS: Router Cut EDGES: Smooth

COLOR: Custom, as noted

GRAPHIC BACKGROUND AND COPY PROCESS: 3M custom screened inks print direct to 3930 with 3M approved UV/ Graffiti Vinyl Over-laminates. (See Color Sheet A6 for all color and material specifications)

FASTENER: Mechanical

Reflective Vinyl Graphics applied to front face of Sign Panel.

See Color Page for Specifications.

Final design and shop drawings shall be supplied by the fabricator. North Carolina registered professional engineer is required to sign and seal the submittal of shop drawings.

- 1. Fabricator shall verify the mounting conditions and provide a detail drawing for each mounting situation, prior to fabrication Fabricator shall obtain approval from the Designer or Client for placement prior to fabrication.
- 2. Welds: All welds shall be ground smooth, paint all seams.


proofread by client and legal requirements checked

- 3. Hardware: All fasteners shall be concealed. If exposed, hardware shall be tamper proof fasteners, corrosion resistant, and color matching adjacent surfaces.
- 4. All painted sign surfaces to receive UV/Anti-Graffiti spray coating. All sign surfaces with reflective graphics to recieve 3M

CLIENT / PROJECT ENVIRONMENTS & EXPERIENCES City of Greenville, NC 120 North Church Street City of Greenville, NC Suite 208 Wayfinding and Signage West Chester, PA 19380 T 484.266.0648 www.merjedesign.com PROJECT NO. Y41-07963 SUBCONSULTANT SHEET TITLE DRAWN BY: KB/GS 6/30/2009 Sign Type PARK.3-4 REVISIONS These drawings are meant for DESIGN INTENT ONLY **Parking Directional** and are not for construction. Contractor shall verify and be responsible for all dimensions and condition of the job. Contractor shall be familiar with the site 05/22/2010 and conditions it presents. This office must be noti-SHEET NO. fied of any variations from the dimensions and cond 08/06/2010 tions shown on this drawing. Shop drawings and details must be submitted to this office for approval **E.1** prior to proceeding with fabrication. All copy shall be 09/01/2010

01/31/2011



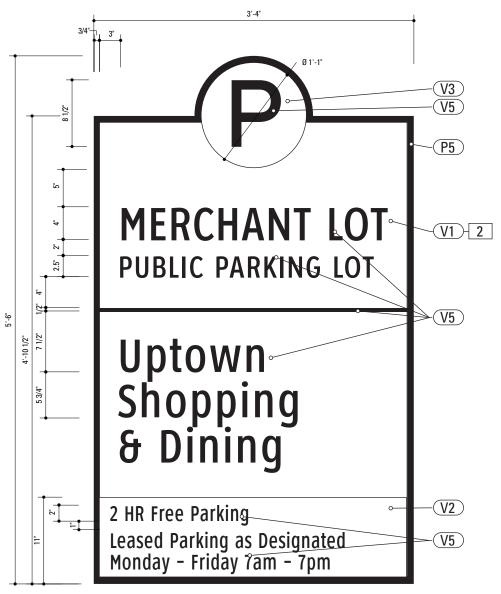

Graphic Layout: PARK.10 SCALE: 1" = 1'-0'

Graphic Layout: PARK.11 SCALE: 1" = 1'-0'

Gary K. Munkelt & Associates
Structural Consulting Engineers
1180 Welsh Rd, Suite 190
North Wales, PA 19454

Phone 215-855-8713 Fax 215-855-8714

SPECIFICATIONS

SIGN TYPE: PARK.10-11 FUNCTION: Parking Identification

2. SIGN PANEL - REFLECTIVE VINYL

MATERIAL: 1/4" thk Aluminu FABRICATION PROCESS: Router Cut EDGES: Smooth

COLOR: Custom, as noted

GRAPHIC BACKGROUND AND COPY PROCESS: 3M custom screened inks print direct to 3930 with 3M approved UV/ Graffiti Vinyl Over-laminates. (See Color Sheet A6 for all color and material specifications)

FASTENER: Mechanical

Reflective Vinyl Graphics applied to front face of Sign Panel.

See Color Page for Specifications.

Final design and shop drawings shall be supplied by the fabricator. North Carolina registered professional engineer is required to sign and seal the submittal of shop drawings.


- 1. Fabricator shall verify the mounting conditions and provide a detail drawing for each mounting situation, prior to fabrication Fabricator shall obtain approval from the Designer or Client for placement prior to fabrication.
- 2. Welds: All welds shall be ground smooth, paint all seams.


proofread by client and legal requirements checked


- 3. Hardware: All fasteners shall be concealed. If exposed, hardware shall be tamper proof fasteners, corrosion resistant, and color matching adjacent surfaces.
- 4. All painted sign surfaces to receive UV/Anti-Graffiti spray coating. All sign surfaces with reflective graphics to recieve 3M

CLIENT / PROJECT ENVIRONMENTS & EXPERIENCES City of Greenville, NC 120 North Church Street City of Greenville, NC Suite 208 merje Wayfinding and Signage West Chester, PA 19380 T 484.266.0648 www.merjedesign.com PROJECT NO. Y41-07963 SUBCONSULTANT SHEET TITLE DRAWN BY: KB/GS 6/30/2009 Sign Type PARK.10-11 These drawings are meant for DESIGN INTENT ONLY REVISIONS **Parking Identification** and are not for construction. Contractor shall verify and be responsible for all dimensions and condition 05/22/2010 of the job. Contractor shall be familiar with the site and conditions it presents. This office must be noti-SHEET NO. fied of any variations from the dimensions and cond 08/06/2010 tions shown on this drawing. Shop drawings and details must be submitted to this office for approva **E.2** prior to proceeding with fabrication. All copy shall be 09/01/2010

01/31/2011

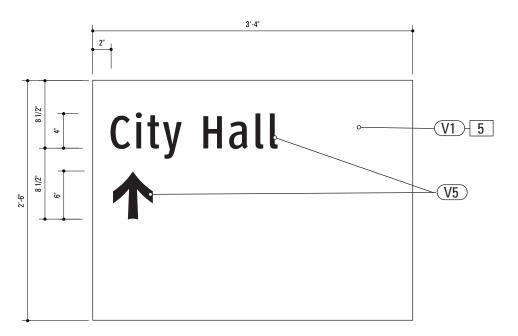

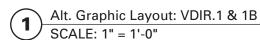

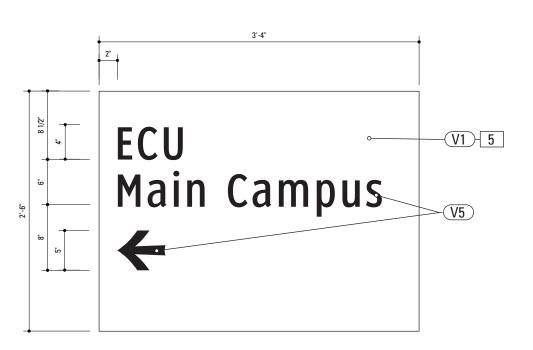

Alt. Graphic Layout: VDIR.1 & 1B SCALE: 1" = 1'-0"

SPECIFICATIONS

SIGN TYPE: VDIR.1-1B FUNCTION: Vehicular Directional

5. SIGN PANEL - REFLECTIVE VINYL

MATERIAL: 1/4" thk Aluminum FABRICATION PROCESS: Router Cut EDGES: Smooth

COLOR: Custom, as noted

GRAPHIC BACKGROUND AND COPY PROCESS: 3M custom

screened inks print direct to 3930 with 3M approved UV/ Graffiti Vinyl Over-laminates. (See Color Sheet A6 for all color

and material specifications) FASTENER: Mechanical

Reflective Vinyl Graphics applied to front face of Sign Panel.

See Color Page for Specifications.

Final design and shop drawings shall be supplied by the fabricator. North Carolina registered professional engineer is required to sign and seal the submittal of shop drawings.


oy legal department.


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- 2. Welds: All welds shall be ground smooth, paint all seams.
- 3. Hardware: All fasteners shall be concealed. If exposed, hardware shall be tamper proof fasteners, corrosion resistant, and color matching adjacent surfaces.
- 4. All painted sign surfaces to receive UV/Anti-Graffiti spray coating. All sign surfaces with reflective graphics to recieve 3M

CLIENT / PROJECT ENVIRONMENTS & EXPERIENCES Clty of Greenville, NC 120 North Church Street City of Greenville, NC Suite 208 Wayfinding and Signage West Chester, PA 19380 T 484.266.0648 www.merjedesign.com PROJECT NO. Y41-07963 SUBCONSULTANT SHEET TITLE DRAWN BY: KB/GS 6/30/2009 Sign Type VDIR.1-1B REVISIONS These drawings are meant for DESIGN INTENT ONLY **Vehicular Directional** and are not for construction. Contractor shall verify and be responsible for all dimensions and condition of the job. Contractor shall be familiar with the site 05/22/2010 and conditions it presents. This office must be noti-SHEET NO. fied of any variations from the dimensions and cond 08/06/2010 tions shown on this drawing. Shop drawings and details must be submitted to this office for approval **E.3** prior to proceeding with fabrication. All copy shall be 09/01/2010 proofread by client and legal requirements checked

01/31/2011

Gary K. Munkelt & Associates Structural Consulting Engineers 1180 Welsh Rd, Suite 190 North Wales, PA 19454

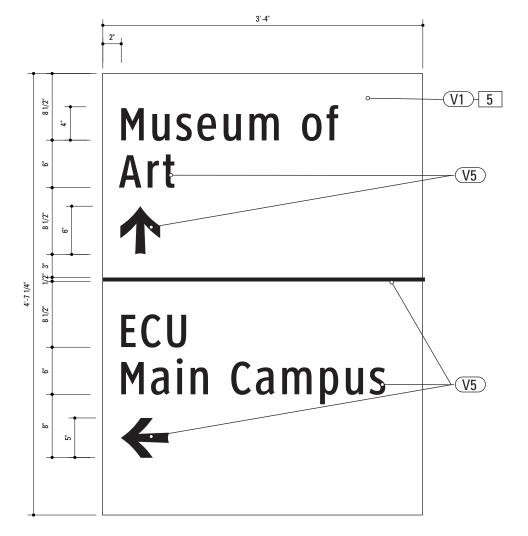

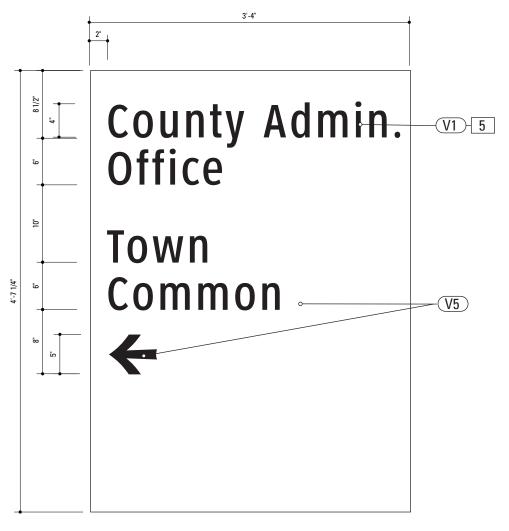

Alt. Graphic Layout: VDIR.2 & 2B SCALE: 1" = 1'-0"

Alt. Graphic Layout: VDIR.2 & 2B SCALE: 1" = 1'-0"

Structural Consulting Engineers 1180 Welsh Rd, Suite 190 North Wales, PA 19454

SPECIFICATIONS

SIGN TYPE: VDIR.2-2B **FUNCTION:** Vehicular Directional

5. SIGN PANEL - REFLECTIVE VINYL

MATERIAL: 1/4" thk Aluminu FABRICATION PROCESS: Router Cut EDGES: Smooth

COLOR: Custom, as noted

GRAPHIC BACKGROUND AND COPY PROCESS: 3M custom screened inks print direct to 3930 with 3M approved UV/ Graffiti Vinyl Over-laminates. (See Color Sheet A6 for all color

and material specifications) FASTENER: Mechanical

Reflective Vinyl Graphics applied to front face of Sign Panel.

See Color Page for Specifications.

Final design and shop drawings shall be supplied by the fabricator. North Carolina registered professional engineer is required to sign and seal the submittal of shop drawings.

Y41-07963

E.4

- 1. Fabricator shall verify the mounting conditions and provide a detail drawing for each mounting situation, prior to fabrication Fabricator shall obtain approval from the Designer or Client for placement prior to fabrication.
- 2. Welds: All welds shall be ground smooth, paint all seams.

prior to proceeding with fabrication. All copy shall be

proofread by client and legal requirements checked


- 3. Hardware: All fasteners shall be concealed. If exposed, hardware shall be tamper proof fasteners, corrosion resistant, and color matching adjacent surfaces.
- 4. All painted sign surfaces to receive UV/Anti-Graffiti spray coating. All sign surfaces with reflective graphics to recieve 3M


CLIENT / PROJECT ENVIRONMENTS & EXPERIENCES City of Greenville, NC 120 North Church Street City of Greenville, NC Suite 208 **Wayfinding and Signage** West Chester, PA 19380 T 484.266.0648 www.merjedesign.com PROJECT NO. SUBCONSULTANT KB/GS 6/30/2009 Sign Type VDIR.2-2B REVISIONS These drawings are meant for DESIGN INTENT ONLY **Vehicular Directional** and are not for construction. Contractor shall verify and be responsible for all dimensions and condition 05/22/2010 of the job. Contractor shall be familiar with the site and conditions it presents. This office must be noti-SHEET NO. fied of any variations from the dimensions and cond 08/06/2010 tions shown on this drawing. Shop drawings and details must be submitted to this office for approval

09/01/2010

01/31/2011

Gary K. Munkelt & Associates

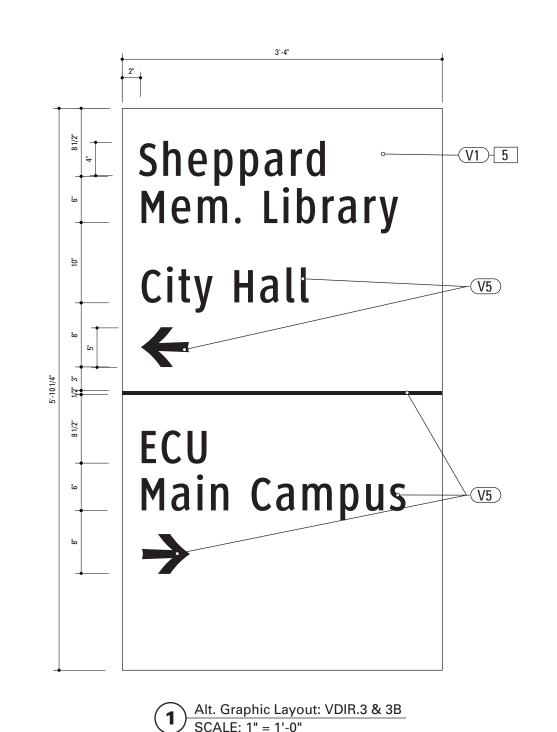

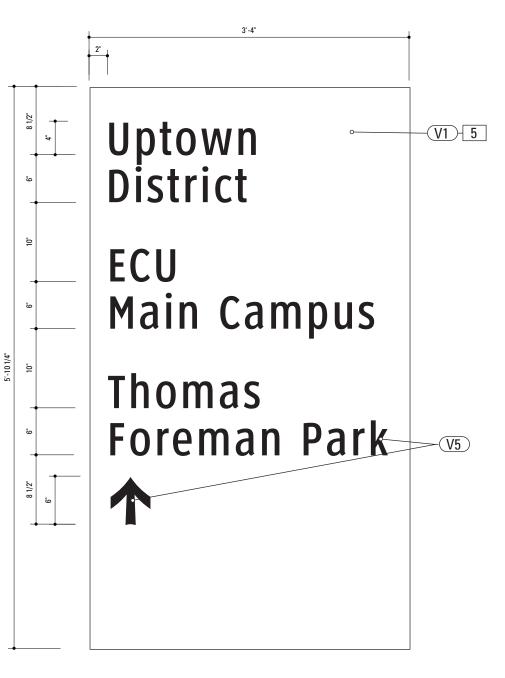

Alt. Graphic Layout: VDIR.3 & 3B SCALE: 1" = 1'-0"

Structural Consulting Engineers 1180 Welsh Rd, Suite 190 North Wales, PA 19454

Phone 215-855-8713 Fax 215-855-8714

SPECIFICATIONS

SIGN TYPE: VDIR.3-3B **FUNCTION:** Vehicular Directional

5. SIGN PANEL - REFLECTIVE VINYL

MATERIAL: 1/4" thk Aluminu FABRICATION PROCESS: Router Cut

EDGES: Smooth COLOR: Custom, as noted

GRAPHIC BACKGROUND AND COPY PROCESS: 3M custom screened inks print direct to 3930 with 3M approved UV/ Graffiti Vinyl Over-laminates. (See Color Sheet A6 for all color

and material specifications) FASTENER: Mechanical

Reflective Vinyl Graphics applied to front face of Sign Panel.

See Color Page for Specifications.

Final design and shop drawings shall be supplied by the fabricator. North Carolina registered professional engineer is required to sign and seal the submittal of shop drawings.

- 1. Fabricator shall verify the mounting conditions and provide a detail drawing for each mounting situation, prior to fabrication Fabricator shall obtain approval from the Designer or Client for placement prior to fabrication.
- 2. Welds: All welds shall be ground smooth, paint all seams.


proofread by client and legal requirements checked

- 3. Hardware: All fasteners shall be concealed. If exposed, hardware shall be tamper proof fasteners, corrosion resistant, and color matching adjacent surfaces.
- 4. All painted sign surfaces to receive UV/Anti-Graffiti spray coating. All sign surfaces with reflective graphics to recieve 3M

CLIENT / PROJECT ENVIRONMENTS & EXPERIENCES City of Greenville, NC 120 North Church Street City of Greenville, NC Suite 208 merje Wayfinding and Signage West Chester, PA 19380 T 484.266.0648 www.merjedesign.com PROJECT NO. Y41-07963 SUBCONSULTANT 6/30/2009 KB/GS Sign Type VDIR.3-3B REVISIONS hese drawings are meant for DESIGN INTENT ONLY **Vehicular Directional** and are not for construction. Contractor shall verify and be responsible for all dimensions and condition of the job. Contractor shall be familiar with the site 05/22/2010 and conditions it presents. This office must be noti-SHEET NO. fied of any variations from the dimensions and cond 08/06/2010 tions shown on this drawing. Shop drawings and details must be submitted to this office for approva **E.5** prior to proceeding with fabrication. All copy shall be 09/01/2010

01/31/2011

Gary K. Munkelt & Associates

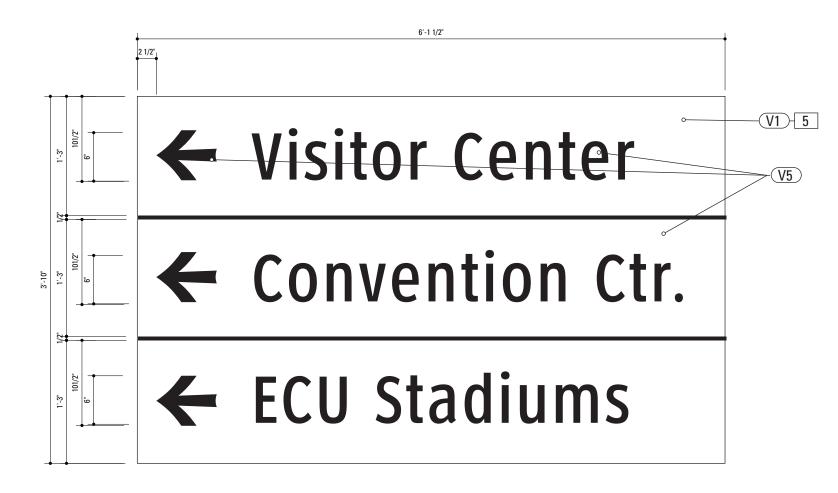

Alt. Graphic Layout: VDIR.4

SCALE: 1" = 1'-0"

SPECIFICATIONS SIGN TYPE: VDIR.4 FUNCTION: Vehicular Directional

5. SIGN PANEL - REFLECTIVE VINYL MATERIAL: 1/4" thk Aluminum

See Color Page for Specifications.

FABRICATION PROCESS: Router Cut
EDGES: Smooth
COLOR: Custom, as noted
GRAPHIC BACKGROUND AND COPY PROCESS: 3M custom
screened inks print direct to 3930 with 3M approved UV/
Graffiti Vinyl Over-laminates. (See Color Sheet A6 for all color
and material specifications)
FASTENER: Mechanical
Reflective Vinyl Graphics applied to front face of Sign Panel.

Final design and shop drawings shall be supplied by the fabricator. North Carolina registered professional engineer is required to sign and seal the submittal of shop drawings.

NOTES

y legal department.


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- 4. All painted sign surfaces to receive UV/Anti-Graffiti spray coating. All sign surfaces with reflective graphics to receive 3M


CLIENT / PROJECT ENVIRONMENTS & EXPERIENCES City of Greenville, NC 120 North Church Street City of Greenville, NC Suite 208 Wayfinding and Signage West Chester, PA 19380 T 484.266.0648 www.merjedesign.com PROJECT NO. Y41-07963 SUBCONSULTANT SHEET TITLE DRAWN BY: 6/30/2009 KB/GS Sign Type VDIR.4 REVISIONS These drawings are meant for DESIGN INTENT ONLY **Vehicular Directional** and are not for construction. Contractor shall verify and be responsible for all dimensions and condition of the job. Contractor shall be familiar with the site 05/22/2010 and conditions it presents. This office must be noti-SHEET NO. fied of any variations from the dimensions and cond 08/06/2010 tions shown on this drawing. Shop drawings and details must be submitted to this office for approva **E.6** prior to proceeding with fabrication. All copy shall be 09/01/2010 proofread by client and legal requirements checked


01/31/2011

Gary K. Munkelt & Associates
Structural Consulting Engineers
1180 Welsh Rd, Suite 190
North Wales, PA 19454

F. Construction Details

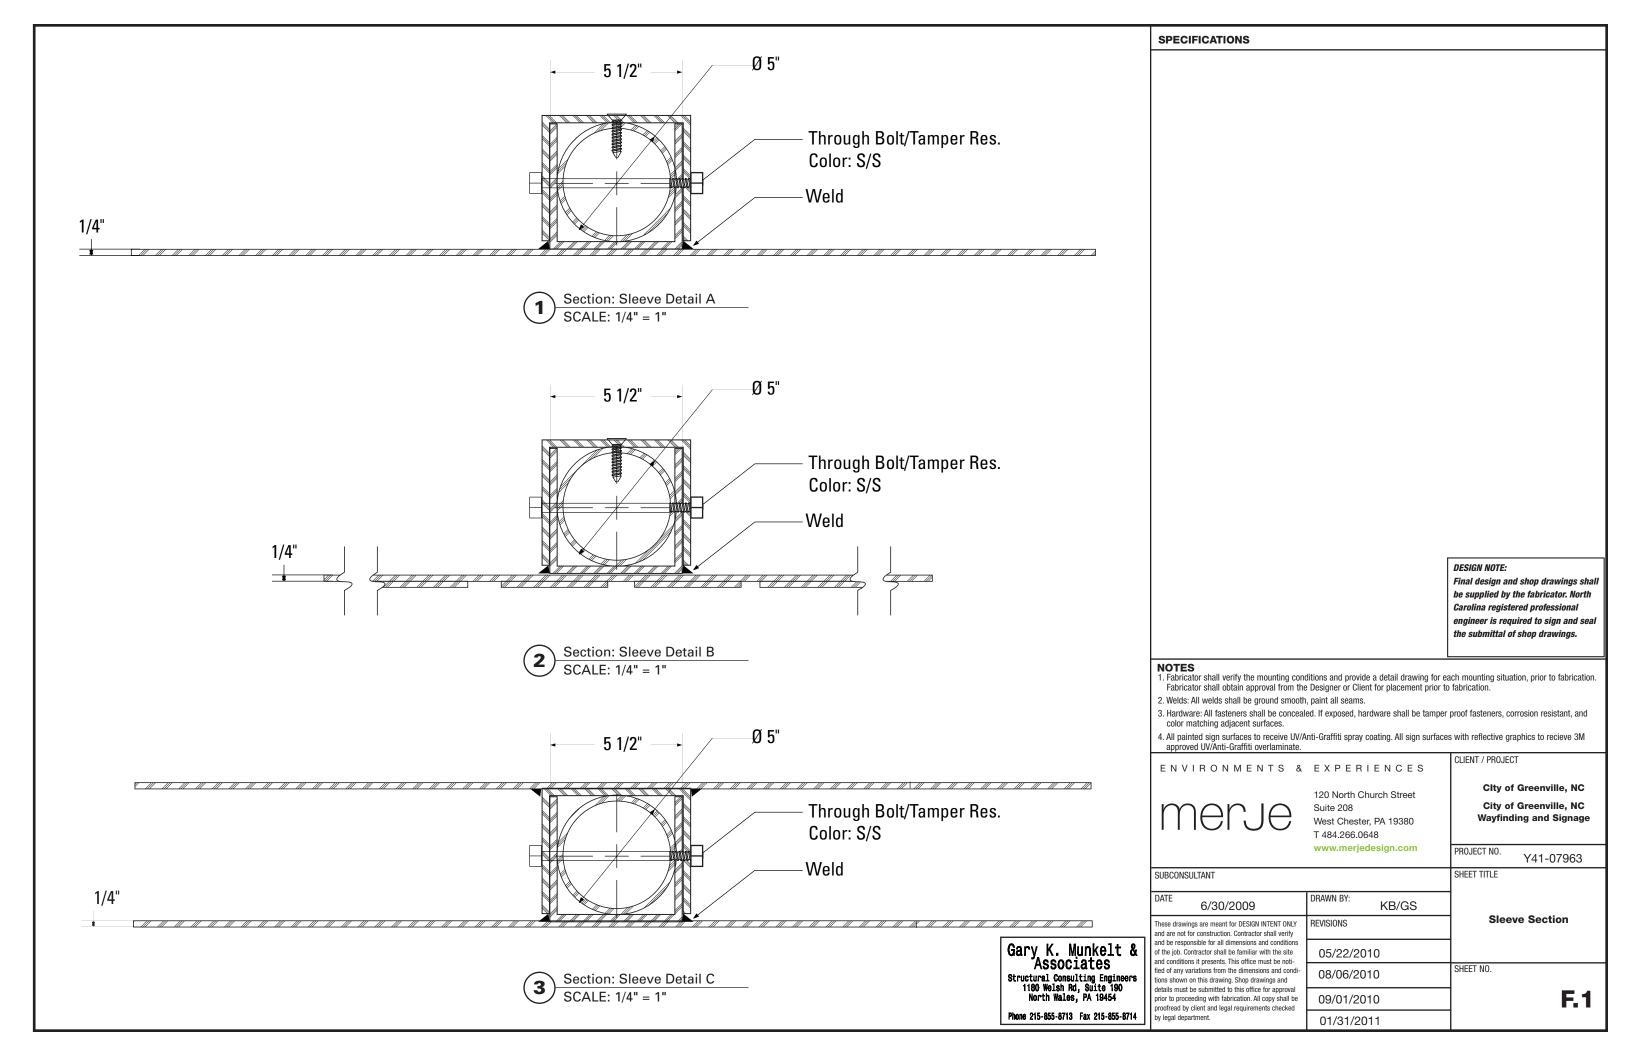

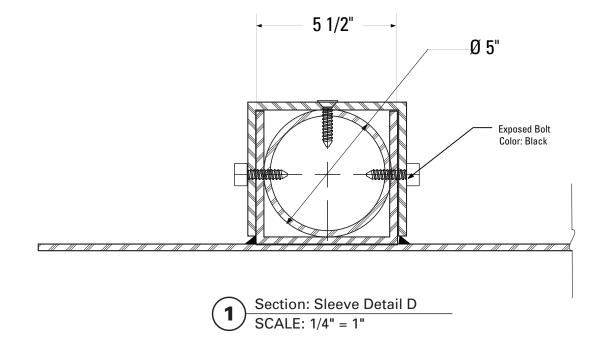

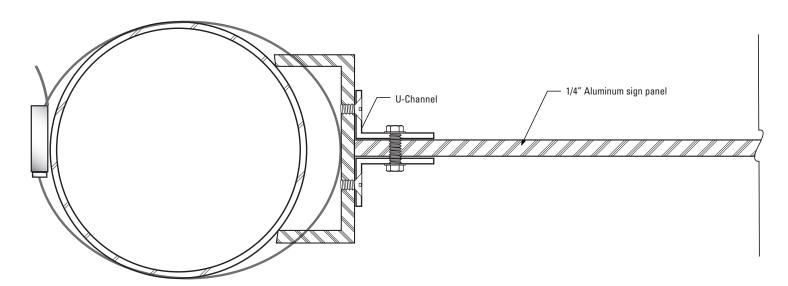

Section: PED.1-2 SCALE: 1/2" = 1"

SPECIFICATIONS

DESIGN NOTE:

Final design and shop drawings shall be supplied by the fabricator. North Carolina registered professional engineer is required to sign and seal the submittal of shop drawings.

- Fabricator shall verify the mounting conditions and provide a detail drawing for each mounting situation, prior to fabrication.
 Fabricator shall obtain approval from the Designer or Client for placement prior to fabrication.
- 2. Welds: All welds shall be ground smooth, paint all seams.
- 3. Hardware: All fasteners shall be concealed. If exposed, hardware shall be tamper proof fasteners, corrosion resistant, and color matching adjacent surfaces.
- All painted sign surfaces to receive UV/Anti-Graffiti spray coating. All sign surfaces with reflective graphics to receive 3M approved UV/Anti-Graffiti overlaminate.

ENVIRONMENTS & EXPERIENCES 120 North Church Street Suite 208 West Chester, PA 19380 T 484.266.0648 www.merjedesign.com SUBCONSULTANT 6/30/2009 These drawings are meant for DESIGN INTENT ONLY and are not for construction. Contractor shall verify and be responsible for all dimensions and conditions of the job. Contractor shall be familiar with the site and conditions it presents. This office must be notified of any variations from the dimensions and conditions shown on this drawing. Shop drawings and

details must be submitted to this office for approval

prior to proceeding with fabrication. All copy shall be proofread by client and legal requirements checked

oy legal department.

Clty of Greenville, NC City of Greenville, NC Wayfinding and Signage

PROJECT NO. Y41-07963

SHEET TITLE

CLIENT / PROJECT

DRAWN BY: KB/GS **Sleeve and Bracket** REVISIONS **Sections** 05/22/2010


09/01/2010

01/31/2011

SHEET NO. 08/06/2010


F.2

Gary K. Munkelt &
ASSOCiates
Structural Consulting Engineers
1180 Welsh Rd, Suite 190
North Wales, PA 19454

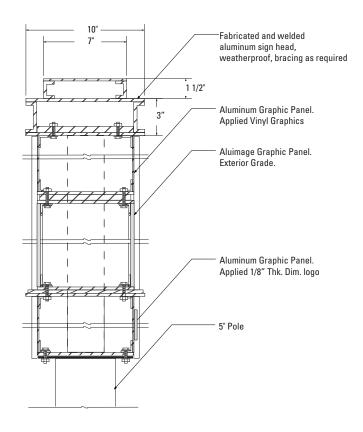


Section: KIOSK.1

SCALE: 1 1/2" = 1'-0"

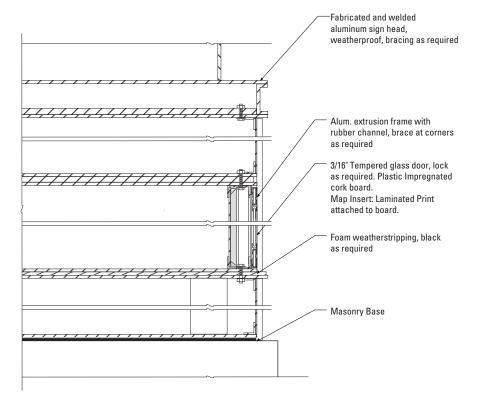

Section: KIOSK.2

SCALE: 1/4" = 1"

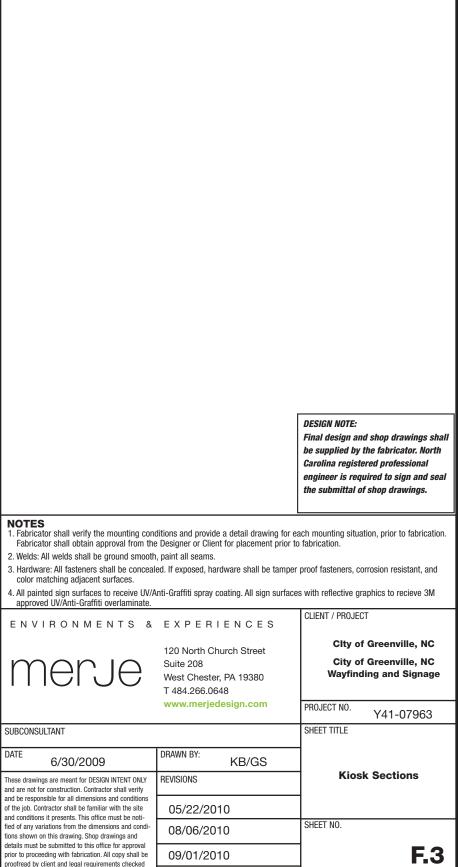


01/31/2011

SPECIFICATIONS

Gary K. Munkelt &
Associates
Structural Consulting Engineers
1180 Welsh Rd, Suite 190
North Wales, PA 19454

Phone 215-855-8713 Fax 215-855-8714

oy legal department.

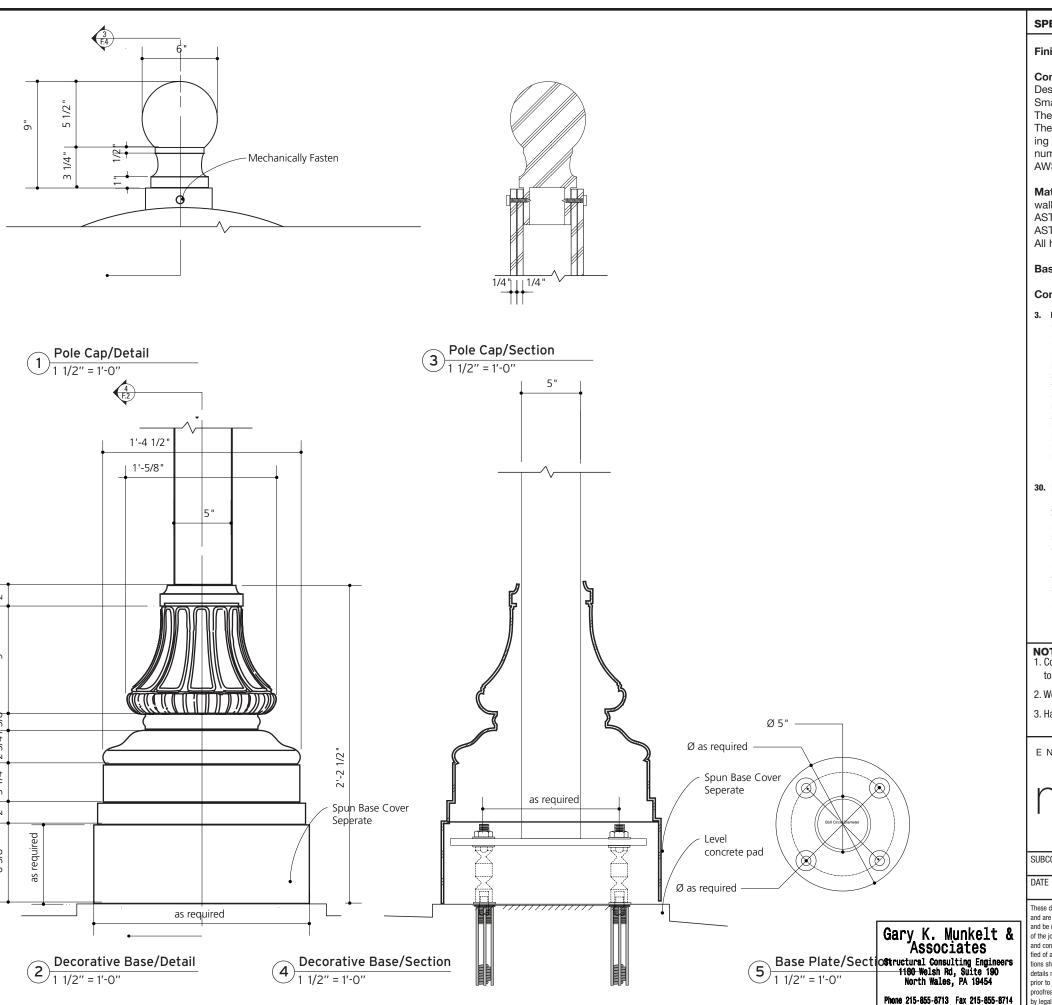

SPECIFICATIONS SIGN TYPE: as specified **FUNCTION:**

Finial SPECIFICATIONS

Construction:

Design Style to match: Halophane Brand Small Post Top Finial BF or approved equal. The finials shall be one-piece construction. The finials shall consist of a one-piece casting or a casting welded to a piece of aluminum tubing. All Welding shall be per ANSI/ AWS D1.2-90

Material: The finial castings shall be heavy wall, cast aluminum produced from certified ASTM 356.1 ingot per ASTM B-179-95a or ASTM B26-95. the tubing shall be aluminum. All hardware shall be Stainless Steel.

Base SPECIFICATIONS

Construction:

3. DECORATIVE BASE

CAST: Wrap around 2 piece base. Mechanically tightened. MATERIAL: Aluminum EDGES: Smooth COLOR: Custom, as noted SURFACE PROCESS: Powdercoated - Finish: Factory Finish from Pole/Base Manufacturer. CLEARCOAT: UV Anti/Graffiti STYLE: HADCO WAB 3000 Series or HAPCO Brand ARLEN. or FASTENER: Mechanically tightened around pole Contractor to provide rubber gaskets were base and pole meet for tight fit. NOTE: A level concrete pad is to be formed to anchor the base, flush to grade,

30. BREAKAWAY FOOTER

Product: TRANSPO Breakaway sign support system or NCDOT Approved equal

Type: Male/Female Coupling assembly.

Base Plate welded to pole. Size and specs to be determined by Contractors structural

NOTE: All signs are positioned within NCDOT R.O.W. and shall be breakaway as per NCDOT Division 9 Breakaway specifica-

Seperate Spun Metal Base Cover hides couplings.

Finish: Factory Finish from Pole/Base Manufacturer.

A seperate Spun Metal Base Cover hides couplings and is coordinated to fit around the Cast Metal Base to accommodate the Transpo Footer. (as shown in Bid Document Drawings.)

Providers of decorative bases (such as Hadco or Hapco) provide the sized pole that matches the opening of the Base. Shop Drawings from the pole/base provider are required for

The design style suggested by the Contractor is subject to Designer/Owner review and approval. Finish: Factory Finish from Pole/Base Manufacturer.

DESIGN NOTE:


Final design and shop drawings shall be supplied by the Contractor. North Carolina registered professional engineer is required to sign and seal the submittal of shop drawings.

- 1. Contractor to verify the mounting conditions and provide a detail drawing for each mounting situation, prior to fabrication. Contractor must obtain approval from the Client or Client for placement prior to fabrication.
- 2. Welds: All welds shall be ground smooth, paint all seams.
- 3. Hardware: All exposed hardware shall be tamper proof fasteners.

ENVIRONMENTS &	EXPERIENCES	CLIENT / PROJECT
merje	120 North Church Street Suite 208 West Chester, PA 19380 T 484.266.0648	City of Greenville, NC City of Greenville, NC Wayfinding and Signage
	www.merjedesign.com	PROJECT NO. Y41-07963
SUBCONSULTANT		SHEET TITLE
DATE 6/30/2009	DRAWN BY: KB/GS	
These drawings are meant for DESIGN INTENT ONLY and are not for construction. Contractor shall verify	REVISIONS	Base and Finial
and be responsible for all dimensions and conditions of the job. Contractor shall be familiar with the site and conditions it presents. This office must be noti-	05/22/2010	Cast Elements
fied of any variations from the dimensions and conditions shown on this drawing. Shop drawings and	08/06/2010	SHEET NO.
details must be submitted to this office for approval prior to proceeding with fabrication. All copy shall be proofread by client and legal requirements checked	09/01/2010	F.4

01/31/2011

G. Footers

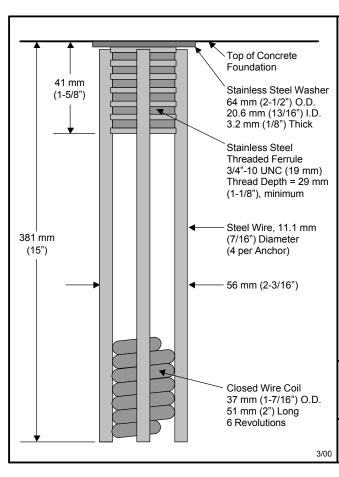

SPECIFICATIONS

Physical Properties:

- 1. Ultimate Tensile Load = 266.9 kN (60.0 kips) minimum per Anchor.
- 2. Actual Pullout Strength depends on foundation design and concrete properties.

Installation Instructions:


See other side of page for typical installation diagrams.


- Fabricate flat steel or wood template with four (4) 19 mm (3/4") diameter holes located to match the specified bolt pattern of the pole base plate.
- 2. Attach four Female Anchors to template using four (4) 19 mm (3/4") diameter bolts. Ensure that each Anchor Washer is flush and snug against the bottom of the template.
- Lower Anchor Assembly into fresh concrete foundation, and vibrate into position such that the tops of the Anchor Washers are flush with the finished top surface of the foundation.
- 4. Support template such that all Anchors are level and in their proper locations.
- 5. Allow concrete to cure, and then remove bolts and template from the top of the foundation.

Transpo® Type C Female Anchor for use with Pole-Safe® Model No. 5075 Breakaway Support System for Light Poles



20 Jones Street New Rochelle, NY 10801 914-636-1000

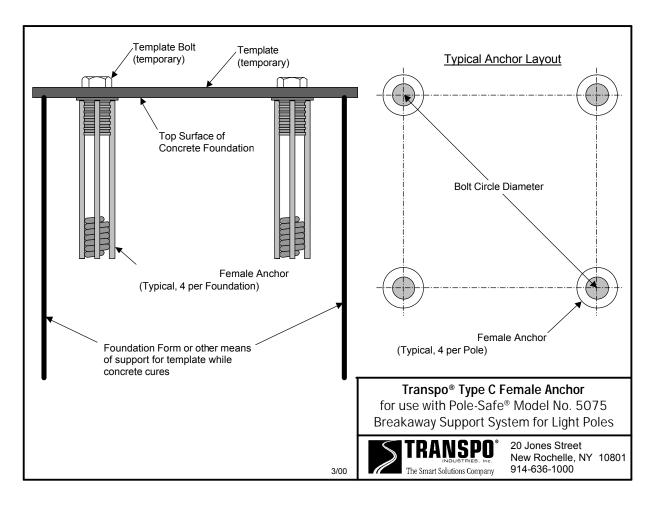

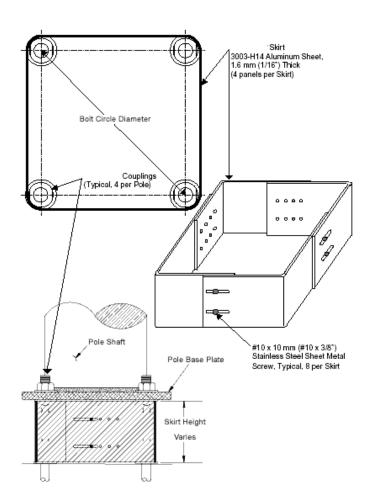

SPECIFICATIONS

PERFORMANCE CRITERIA:

- Double-Neck Pole-Safe meets all requirements of "AASHTO Standard Specifications for Structural Supports for Highway Signs, Luminaries, and Traffic Signals."
- 2. Double-Neck Pole-Safe has been crash-tested and FHWA approved in accordance with the requirements of NCHRP Report 350, "Recommended Procedures for the Safety Performance Evaluation of Highway Features."
- 3. Maximum Allowable Pole Mass = 450 kg (922 lb) (total including fixtures).

PHYSICAL PROPERTIES PER COUPLING:

- 1. Ultimate Tensile Strength = 221.5 kN (49.8 kips), minimum
- 2. Tensile Yield Strength = 192.0 kN (43.2 kips), minimum.
- 3. Ultimate Restrained Shear Strength = 24.5 kN (5.5 kips), maximum

CORROSION PROTECTION:

All Hardware items are American Standard sizes, galvanized in accordance with ASTM A153 (hot dipped).

DESIGN NOTE:


Final design and shop drawings shall be supplied by the fabricator. North Carolina registered professional engineer is required to sign and seal the submittal of shop drawings.

IOTES

- Contractor to verify the mounting conditions and provide a detail drawing for each mounting situation, prior to fabrication. Contractor must obtain approval from the Client or Client for placement prior to fabrication.
- 2. Welds: All welds shall be ground smooth, paint all seams.
- 3. Hardware: All exposed hardware shall be tamper proof fasteners.



Gary K. Munkelt & Associates
Structural Consulting Engineers
1180 Welsh Rd, Suite 190
North Wales, PA 19454

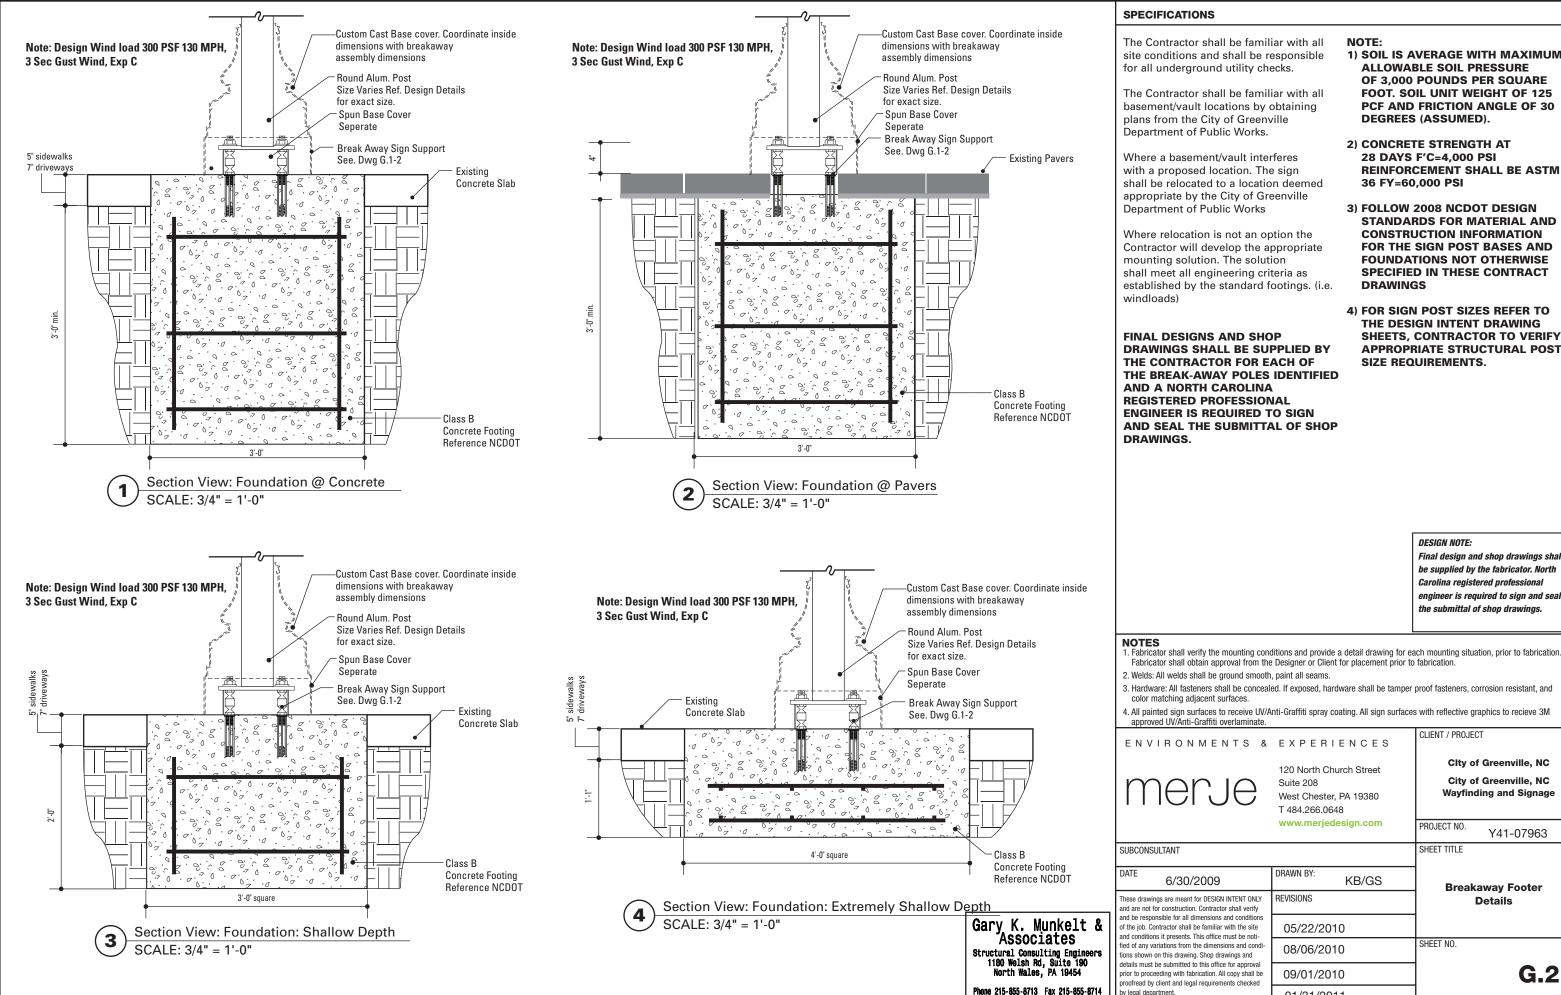


- 1) SOIL IS AVERAGE WITH MAXIMUM ALLOWABLE SOIL PRESSURE **OF 3,000 POUNDS PER SQUARE FOOT. SOIL UNIT WEIGHT OF 125 PCF AND FRICTION ANGLE OF 30 DEGREES (ASSUMED).**
- 2) CONCRETE STRENGTH AT 28 DAYS F'C=4,000 PSI **REINFORCEMENT SHALL BE ASTM** 36 FY=60,000 PSI
- 3) FOLLOW 2008 NCDOT DESIGN STANDARDS FOR MATERIAL AND **CONSTRUCTION INFORMATION** FOR THE SIGN POST BASES AND **FOUNDATIONS NOT OTHERWISE SPECIFIED IN THESE CONTRACT DRAWINGS**
- 4) FOR SIGN POST SIZES REFER TO THE DESIGN INTENT DRAWING SHEETS, CONTRACTOR TO VERIFY **APPROPRIATE STRUCTURAL POST SIZE REQUIREMENTS.**

DESIGN NOTE:


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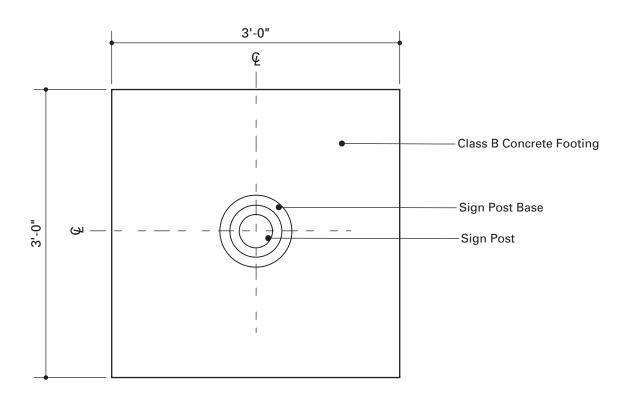
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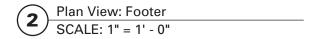




NOTE: When locating a footer within a single pavement block (max. 5'-0" x 5'-0"), adjacent to at least 2 expansion joints, the entire block of pavement shall be removed and replaced with the same materials and finish of adjacent sidewalk areas.

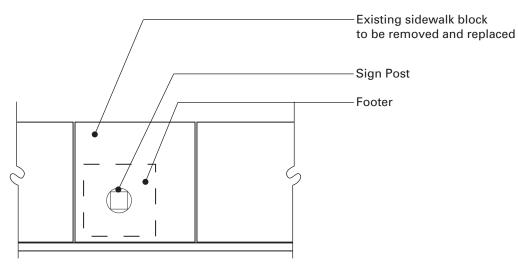



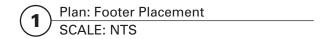

SPECIFICATIONS

The Contractor shall be familiar with all site conditions and shall be responsible for all underground utility checks.

The Contractor shall be familiar with all basement/vault locations by obtaining plans from the City of Greenville Department of Public Works.

Where a basement/vault interferes with a proposed location. The sign shall be relocated to a location deemed appropriate by the City of Greenville Department of Public Works

Where relocation is not an option the Contractor will develop the appropriate mounting solution. The solution shall meet all engineering criteria as established by the standard footings. (i.e. windloads)

FINAL DESIGNS AND SHOP DRAWINGS SHALL BE SUPPLIED BY THE CONTRACTOR FOR EACH OF THE BREAK-AWAY POLES IDENTIFIED AND A NORTH CAROLINA REGISTERED PROFESSIONAL ENGINEER IS REQUIRED TO SIGN AND SEAL THE SUBMITTAL OF SHOP DRAWINGS.

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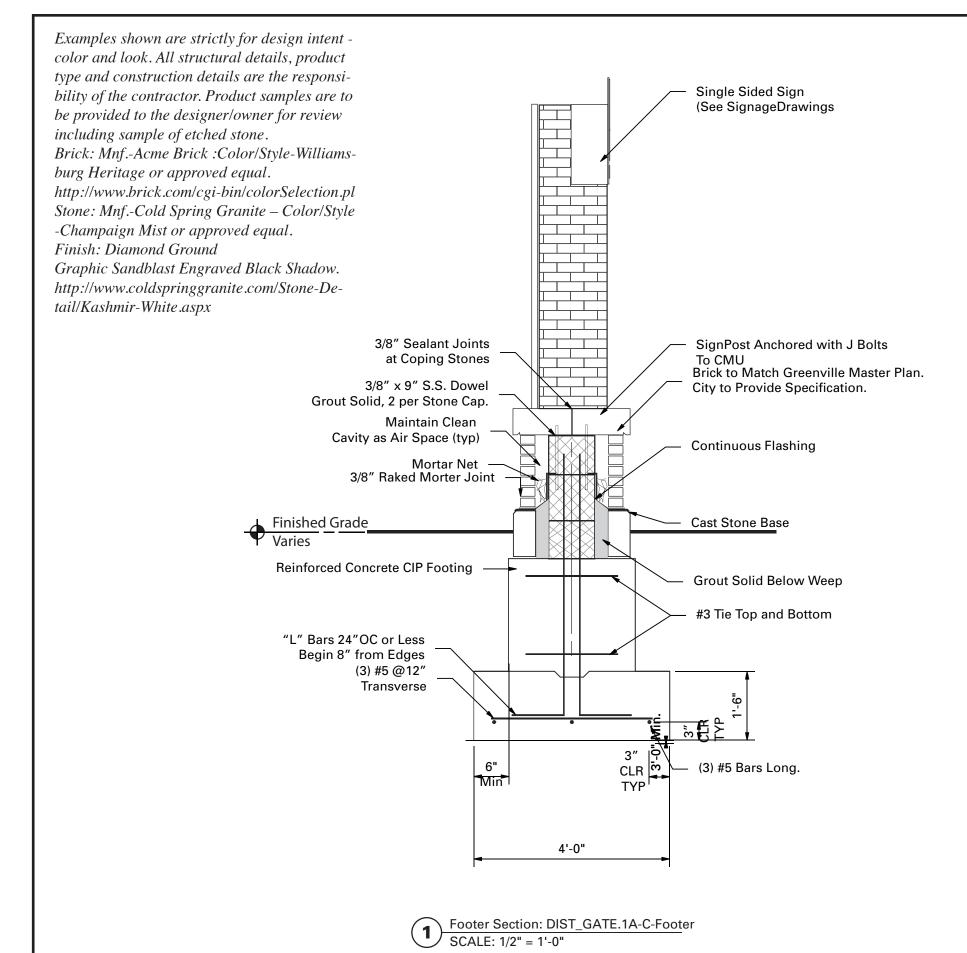
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- 4. All painted sign surfaces to receive UV/Anti-Graffiti spray coating. All sign surfaces with reflective graphics to recieve 3M

CLIENT / PROJECT ENVIRONMENTS & EXPERIENCES Clty of Greenville, NC 120 North Church Street City of Greenville, NC Suite 208 Wayfinding and Signage West Chester, PA 19380 T 484.266.0648 www.merjedesign.com PROJECT NO. Y41-07963 SUBCONSULTANT SHEET TITLE DRAWN BY: 6/30/2009 KB/GS **Breakaway Footer** These drawings are meant for DESIGN INTENT ONLY REVISIONS **Details** and are not for construction. Contractor shall verify and be responsible for all dimensions and conditio of the job. Contractor shall be familiar with the site 05/22/2010 and conditions it presents. This office must be noti-SHEET NO. fied of any variations from the dimensions and cond 08/06/2010 tions shown on this drawing. Shop drawings and details must be submitted to this office for approva **G.3** prior to proceeding with fabrication. All copy shall be 09/01/2010 roofread by client and legal requirements checked

01/31/2011

Gary K. Munkelt &
Associates
Structural Consulting Engineers
1180 Welsh Rd, Suite 190
North Wales, PA 19454



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Structural Consulting Engineers
1180 Welsh Rd, Suite 190
North Wales, PA 19454

Phone 215-855-8713 Fax 215-855-8714


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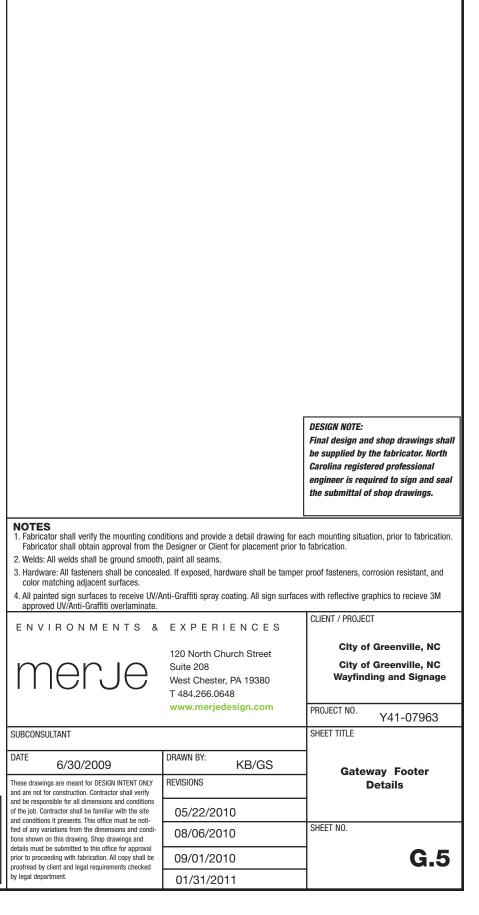
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SPECIFICATIONS

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Examples shown are strictly for design intent - color and look. All structural details, product type and construction details are the responsibility of the contractor.

Product samples are to be provided to the designer/owner for review including sample of etched stone.

Brick: Mnf.-Acme Brick: Color/Style-Williamsburg Heritage or approved equal.


http://www.brick.com/cgi-bin/colorSelection.pl

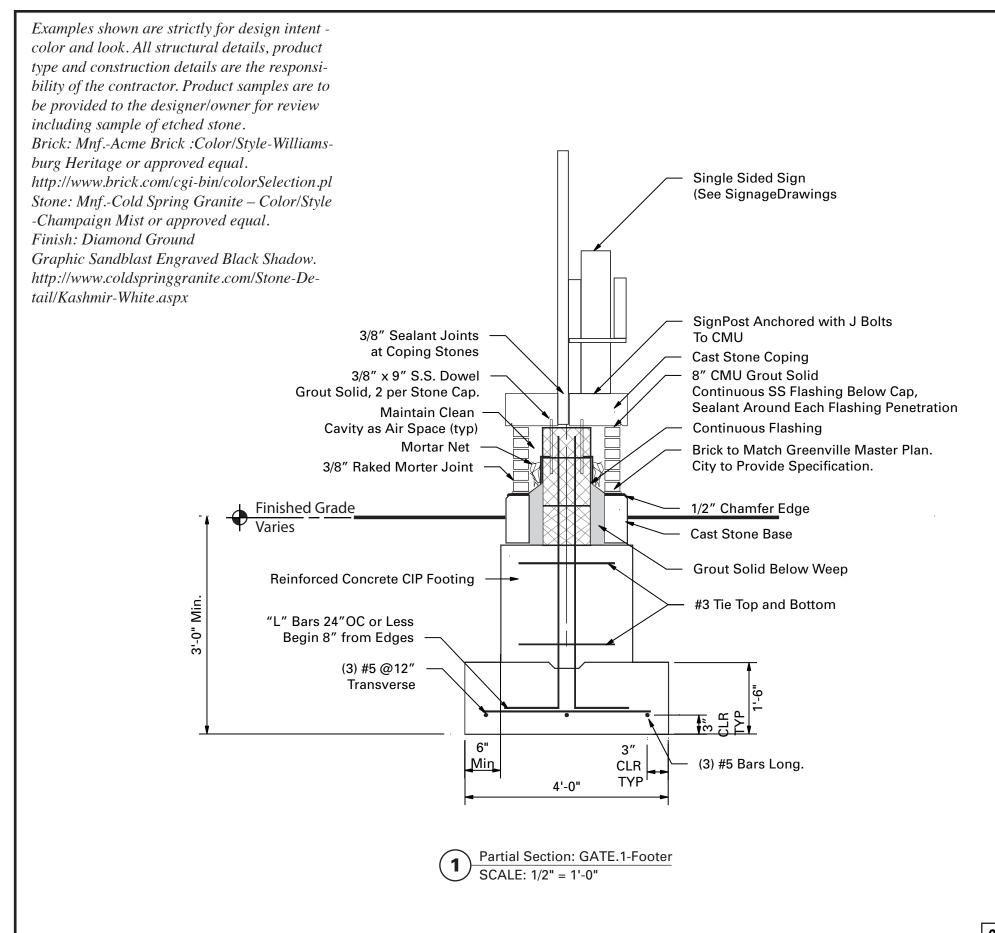
Stone: Mnf.-Cold Spring Granite – Color/Style -Champaign Mist or approved equal.


Finish: Diamond Ground


Graphic Sandblast Engraved Black Shadow.

http://www.coldspringgranite.com/Stone-Detail/Kashmir-White.aspx

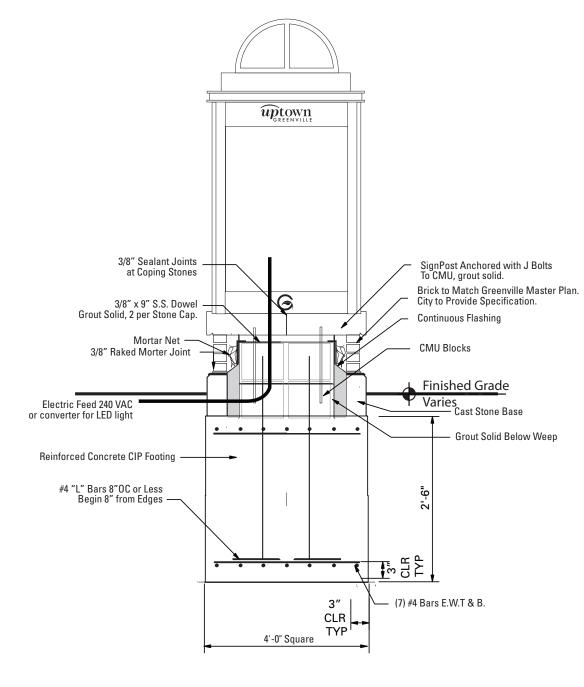

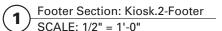

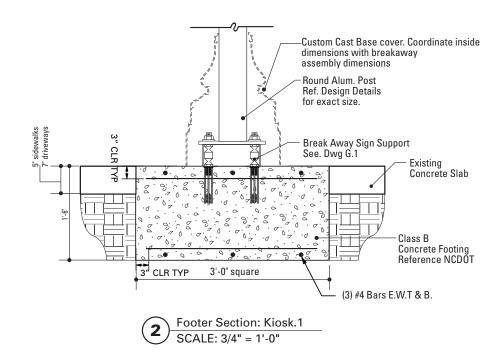

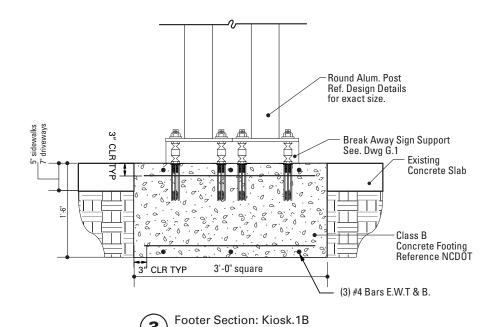

SCALE: 3/4" = 1'-0"

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1180 Welsh Rd, Suite 190

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Phone 215-855-8713 Fax 215-855-8714

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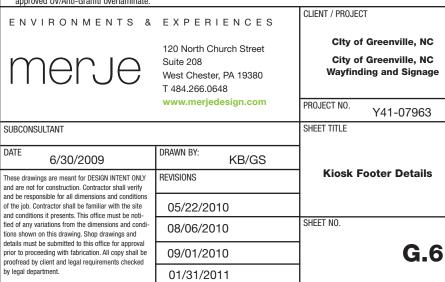
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SECTION 2 | Programming

City of Greenville

Signage and Identity System

Sign Location Program, Message Schedule, and Removal Plan January 2011




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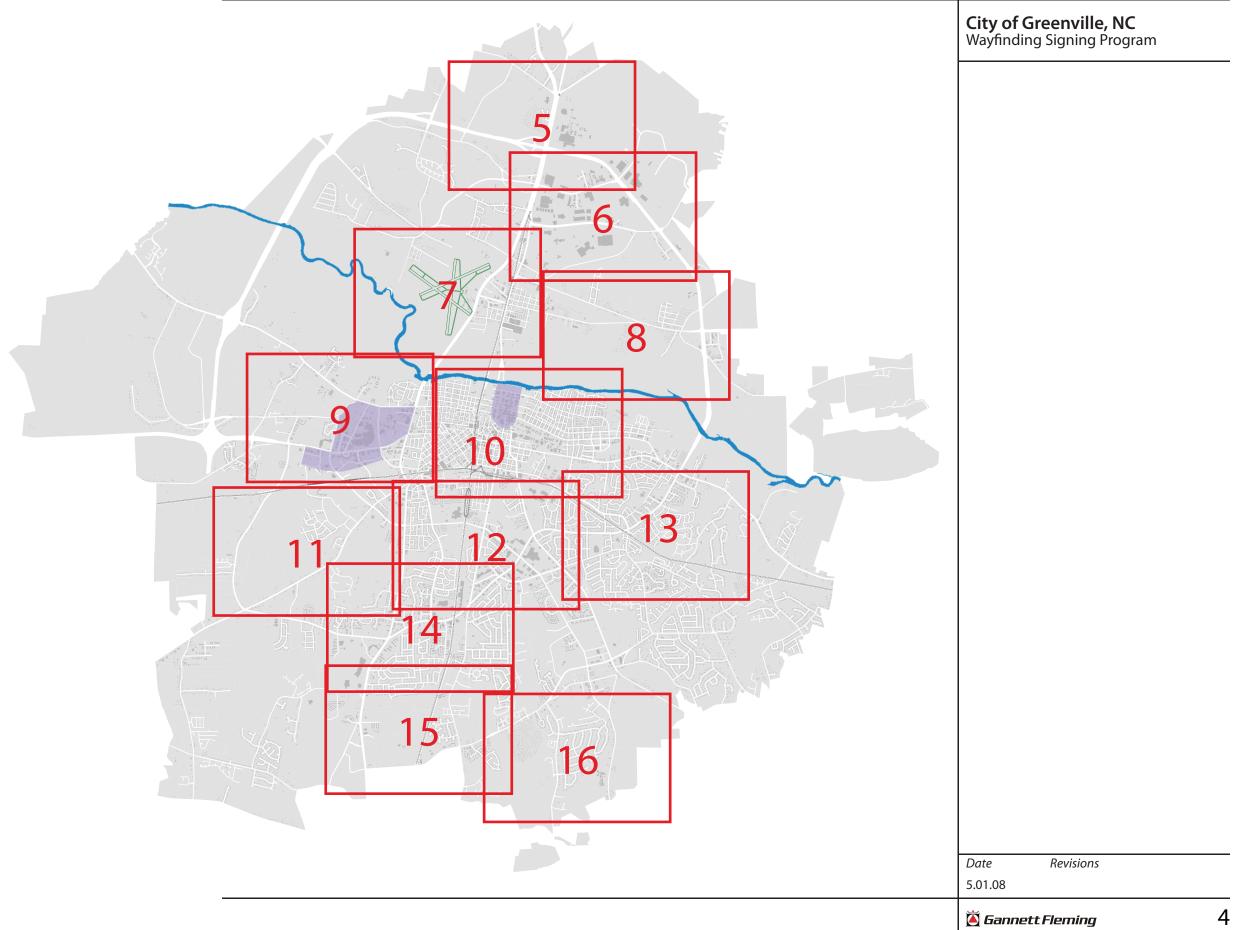
Sign Program - Citywide & 10th St Connector	
Message Schedule	1
Removal Plan	3





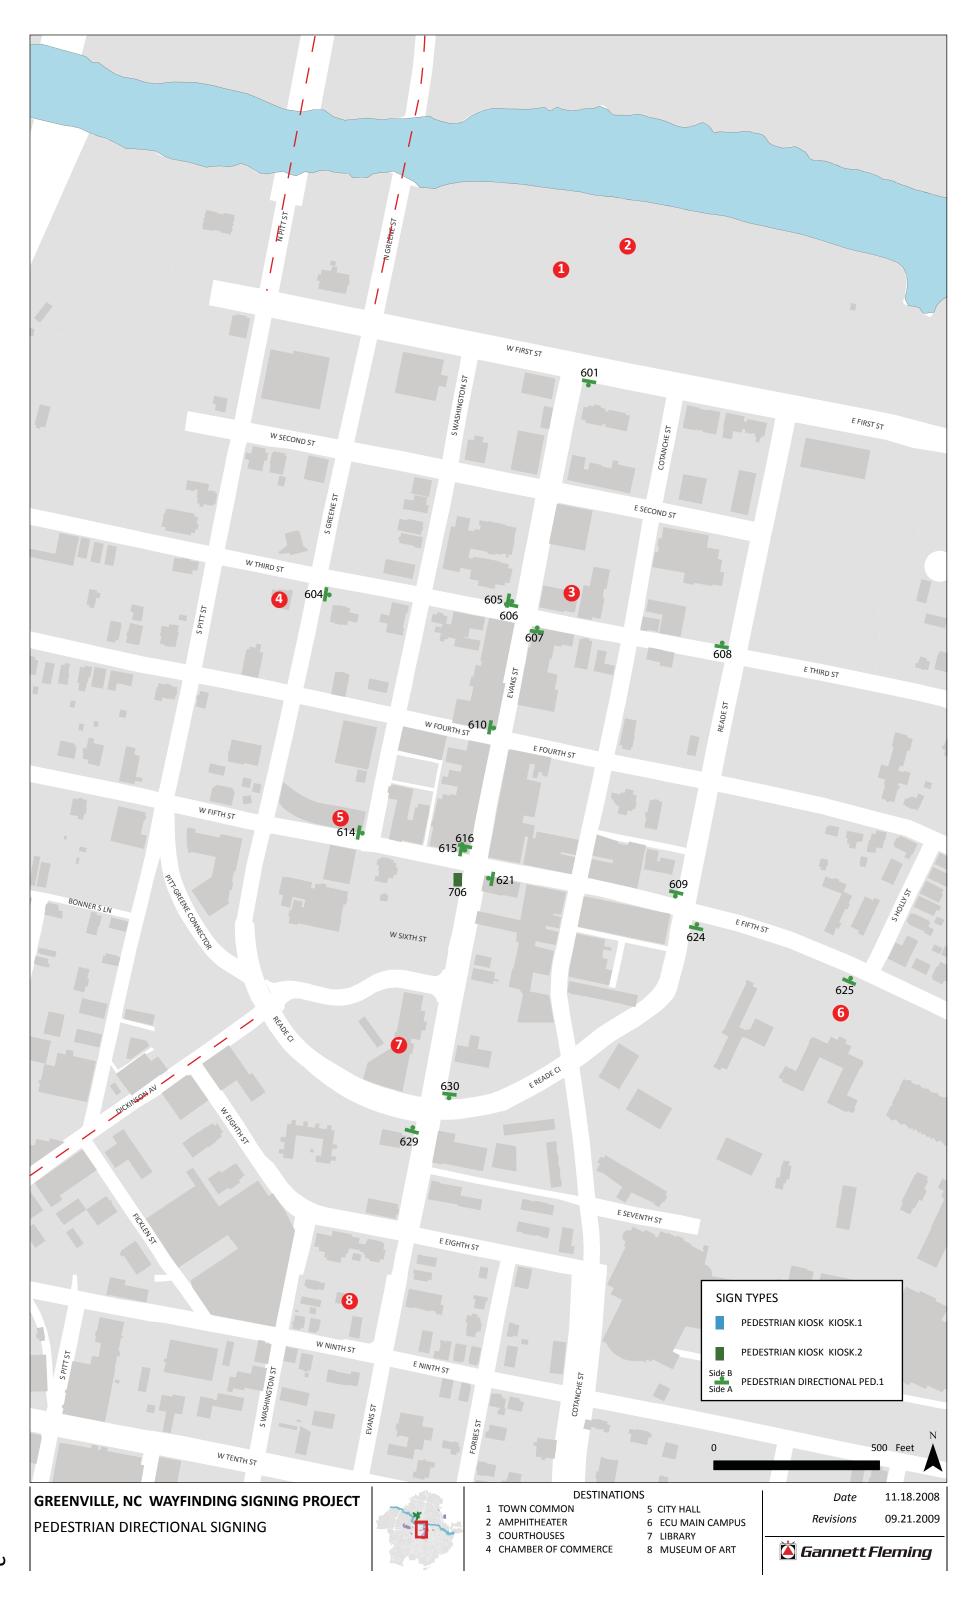

Citywide Key Map





City of Greenville, NC Wayfinding Signing Program

Destinations

Town Common
Amphitheatre
Courthouses
Chamber of
Commerce
City Hall
ECU Main Campus
Sheppard Mem.
Library
Museum of Art
Uptown District
O Airport
Hospital

ECU Stadiums


- 13 Pitt Comm
 College
 14 Medical District
 16 County Admin.
 Office
 us 17 Convention
 Center
 - Visitors Center
 G.W. Carver

 Branch Library


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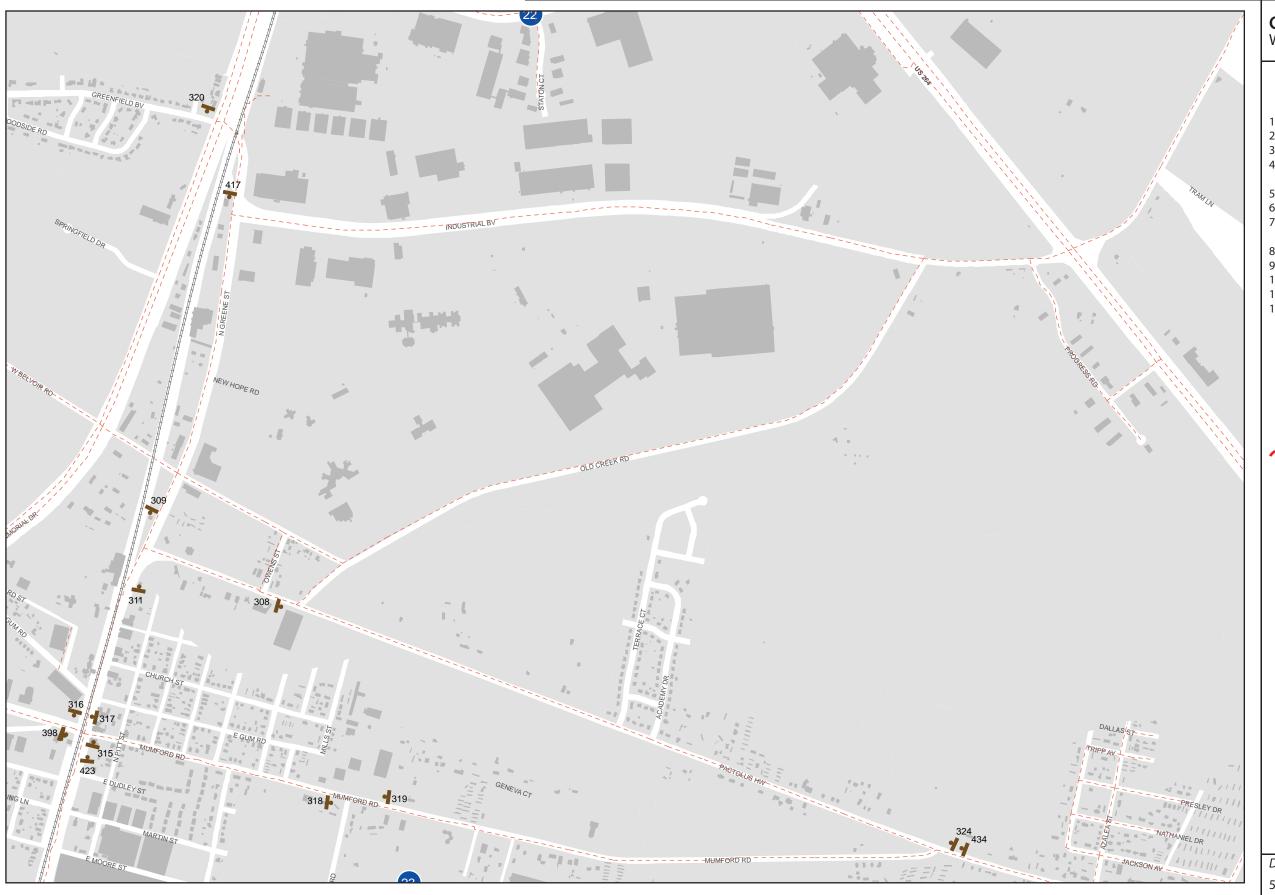
 Library
 Industrial Parks
 - 23 Science and Nature Center

State-Maintained Road

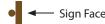

Key Map



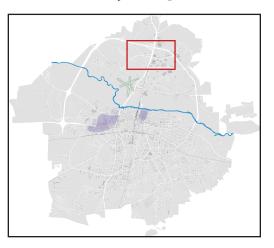

City of Greenville, NC Wayfinding Signing Program

Destinations

13

20

Pitt Comm

College

14 Medical District

County Admin.


Convention

G.W. Carver Branch Library


Visitors Center


Center

- Town Common
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 Nature Center
- State-Maintained Road

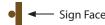

Key Map

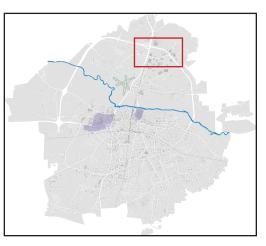

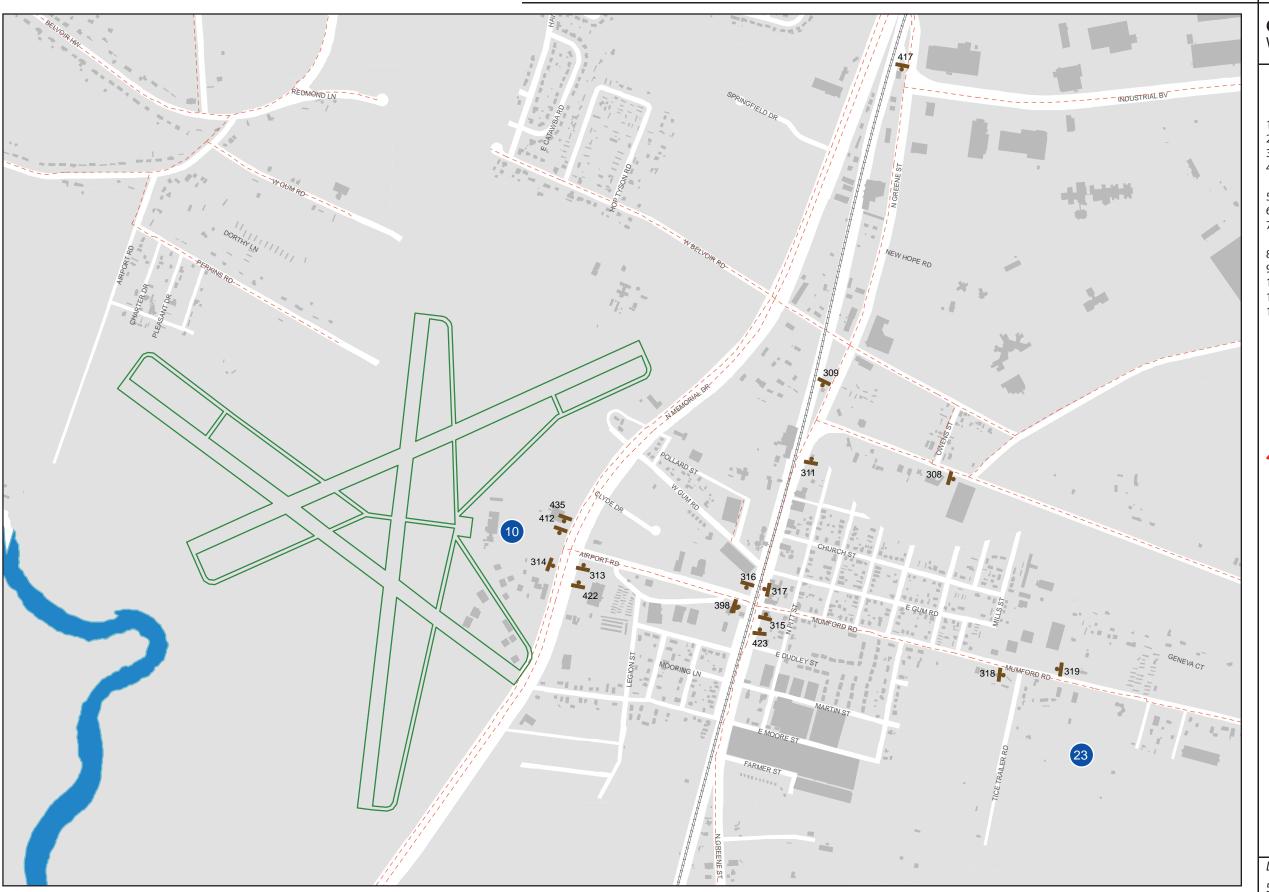

City of Greenville, NC Wayfinding Signing Program

Destinations

13

Pitt Comm

Medical District


County Admin.


College

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 Uptown District
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 t 20 G.W. Carver
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 Library
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 23 Science and
 Nature Center
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- **←** Sign Face

Key Map



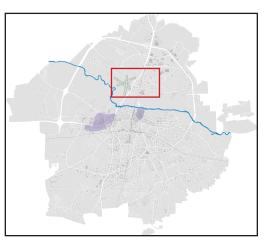

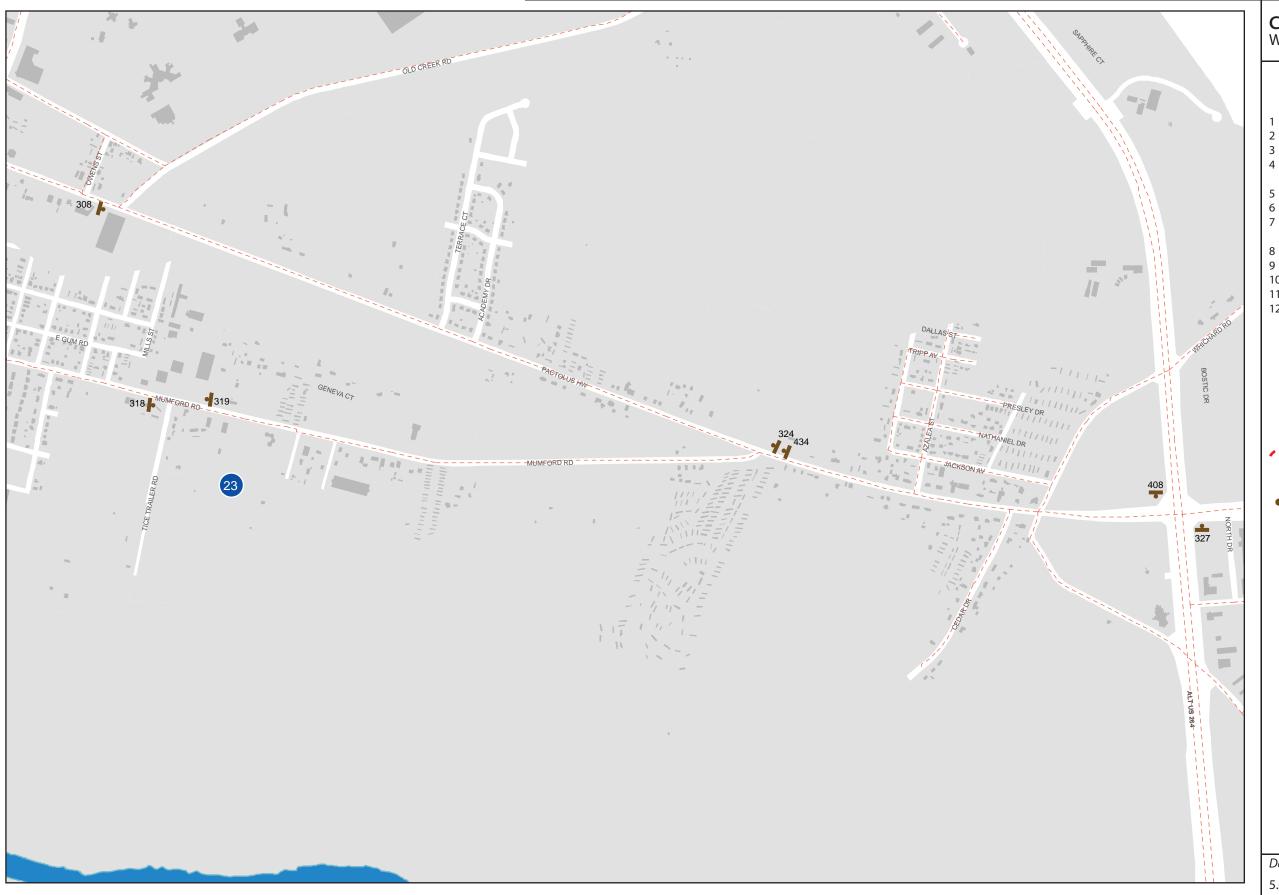City of Greenville, NC Wayfinding Signing Program

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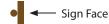
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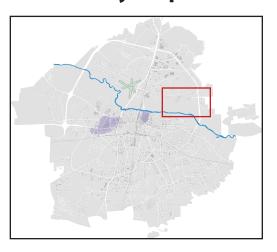
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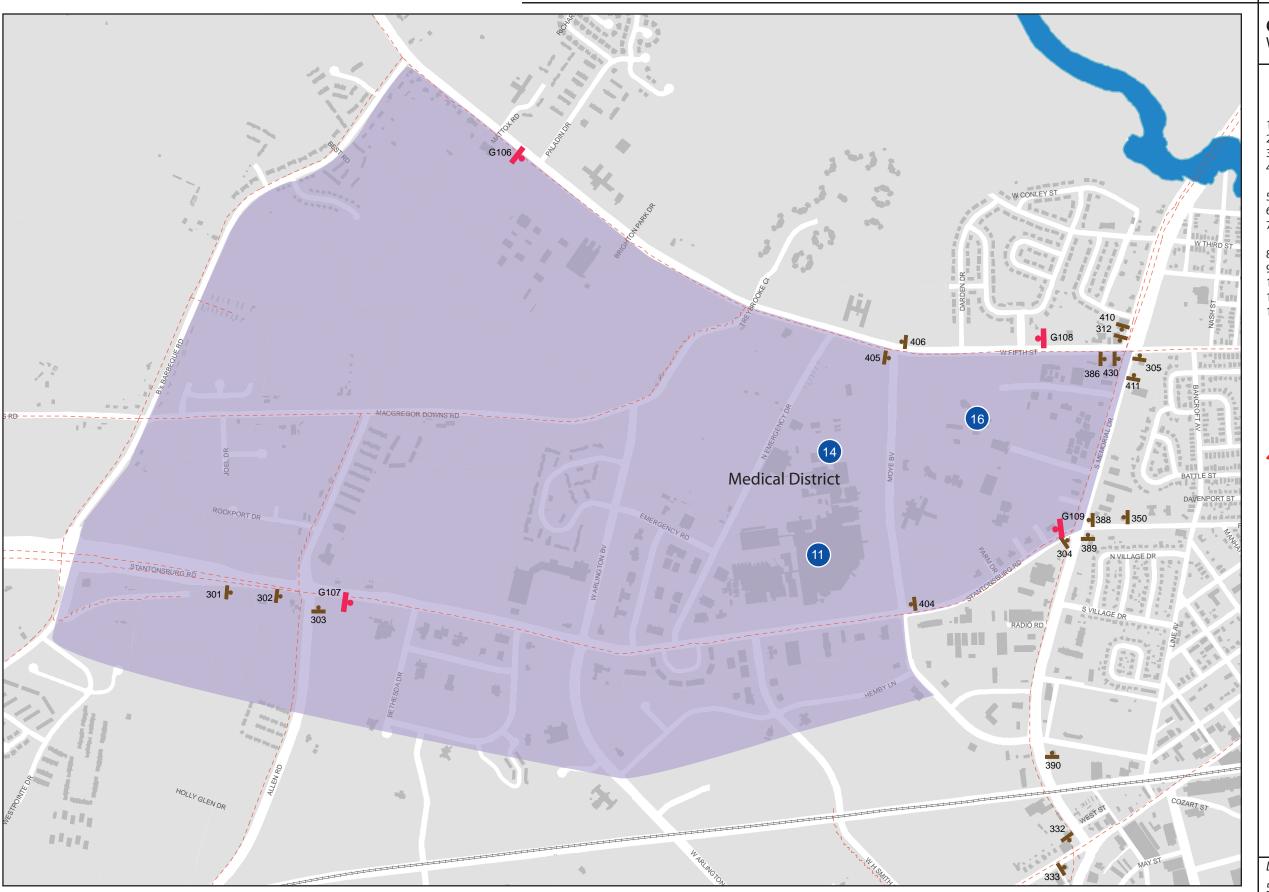
- Office Convention Center Visitors Center
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State-Maintained Road



Key Map





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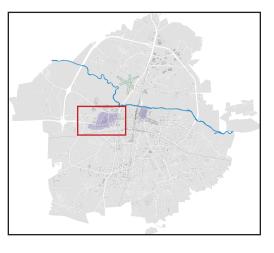
- 13 Pitt Comm College
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State-Maintained Road



Key Map





City of Greenville, NC Wayfinding Signing Program

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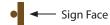
Town Common	
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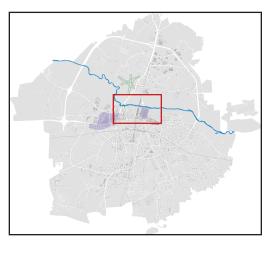
 County Admin.
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 8 Visitors Center
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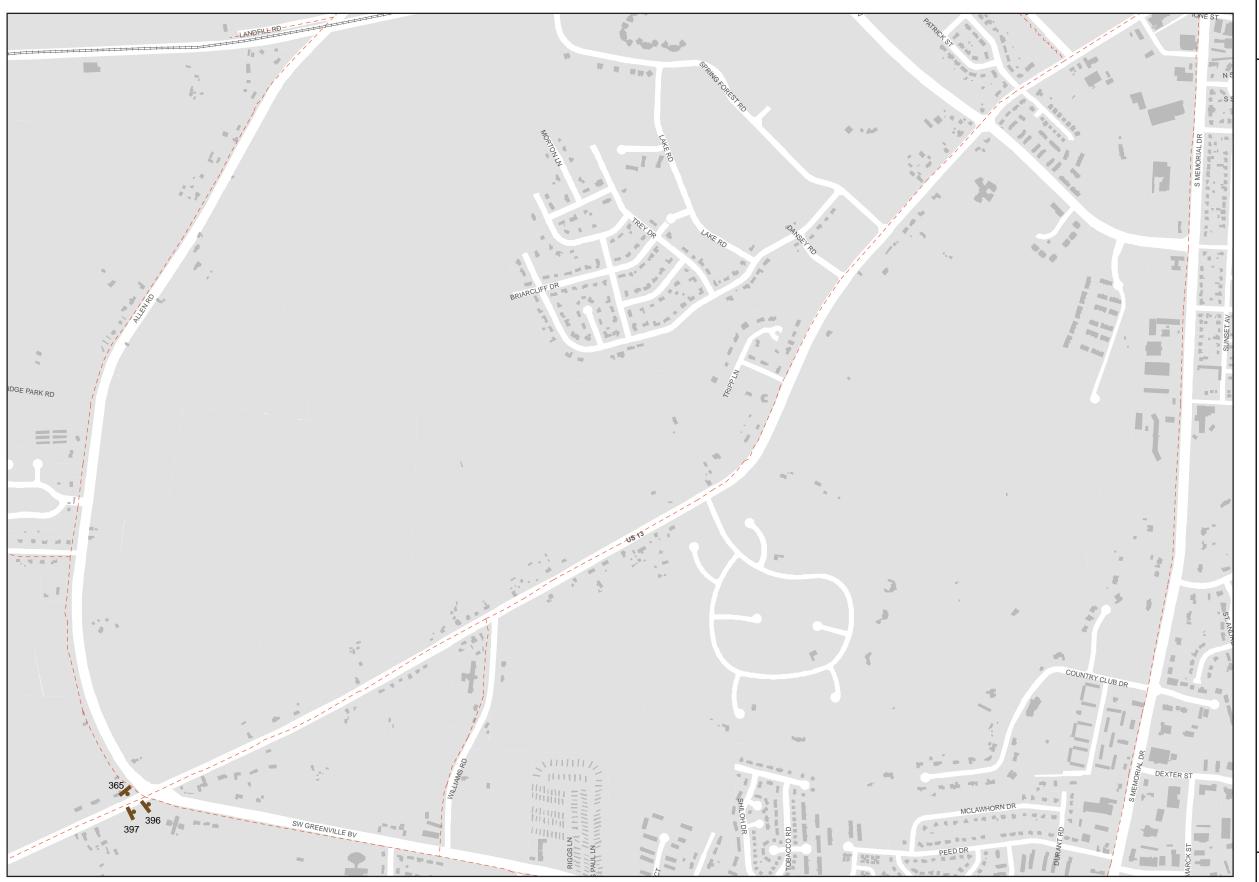


State-Maintained Road



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13 Pitt CommCollege14 Medical District

County Admin.OfficeConventionCenter


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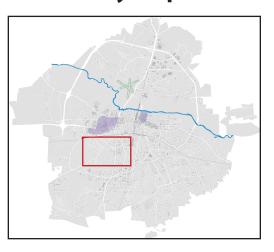
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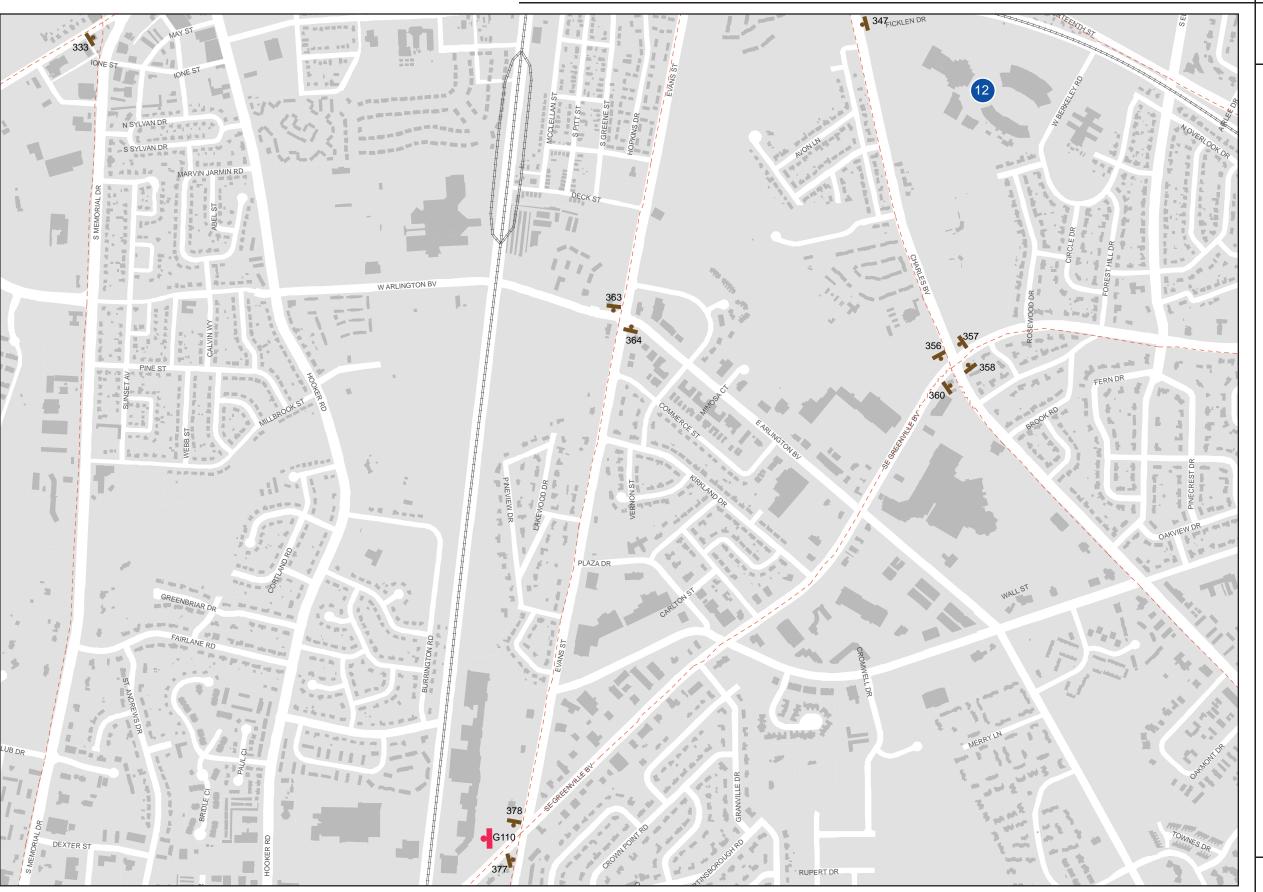
Nature Center

State-Maintained Road



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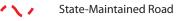


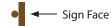


City of Greenville, NC Wayfinding Signing Program


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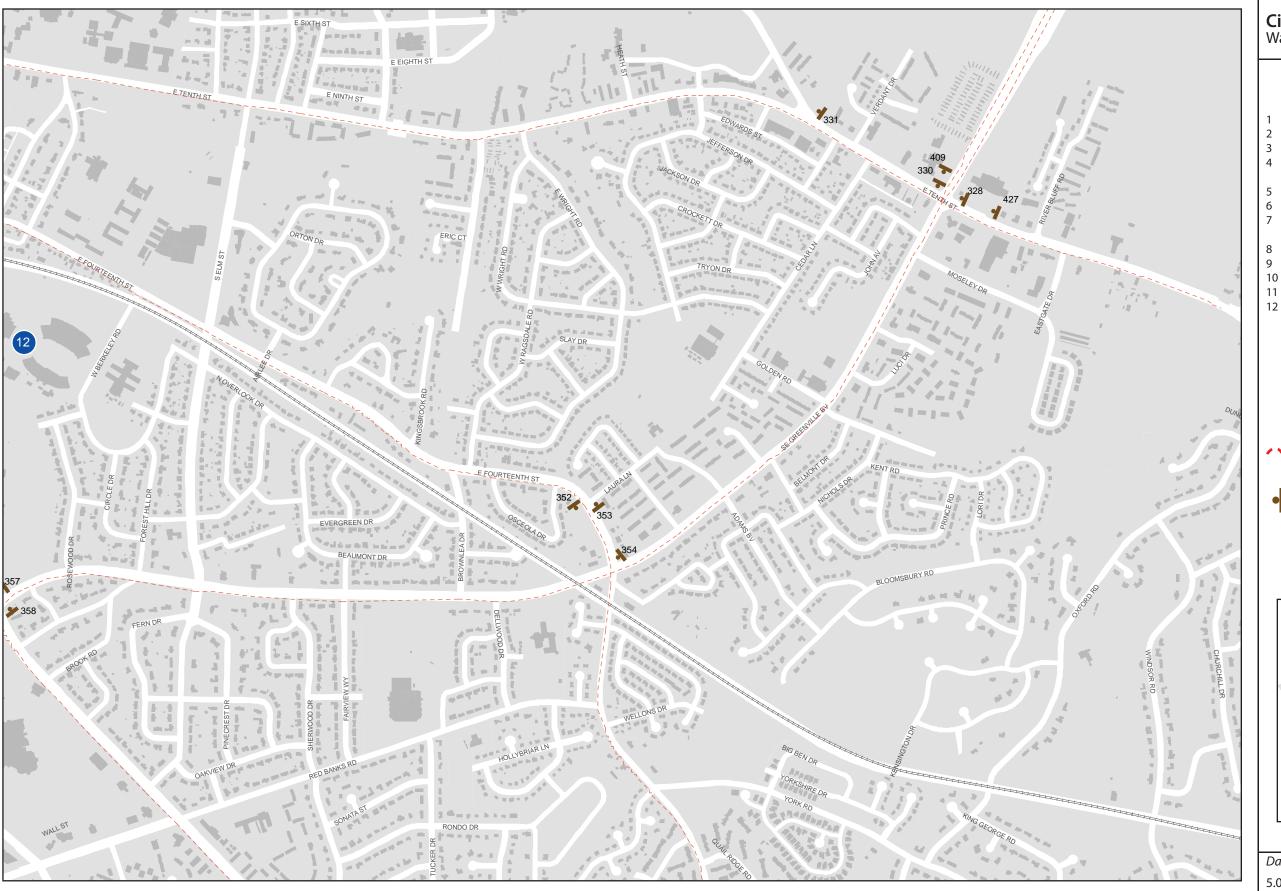
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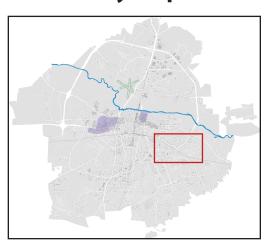
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Branch Library
East Branch
Library


22 Industrial Parks23 Science and Nature Center

State-Maintained Road

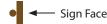● Sign Face

Key Map

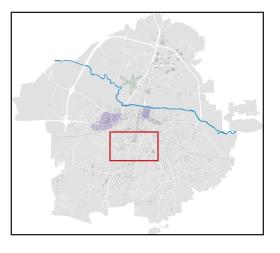

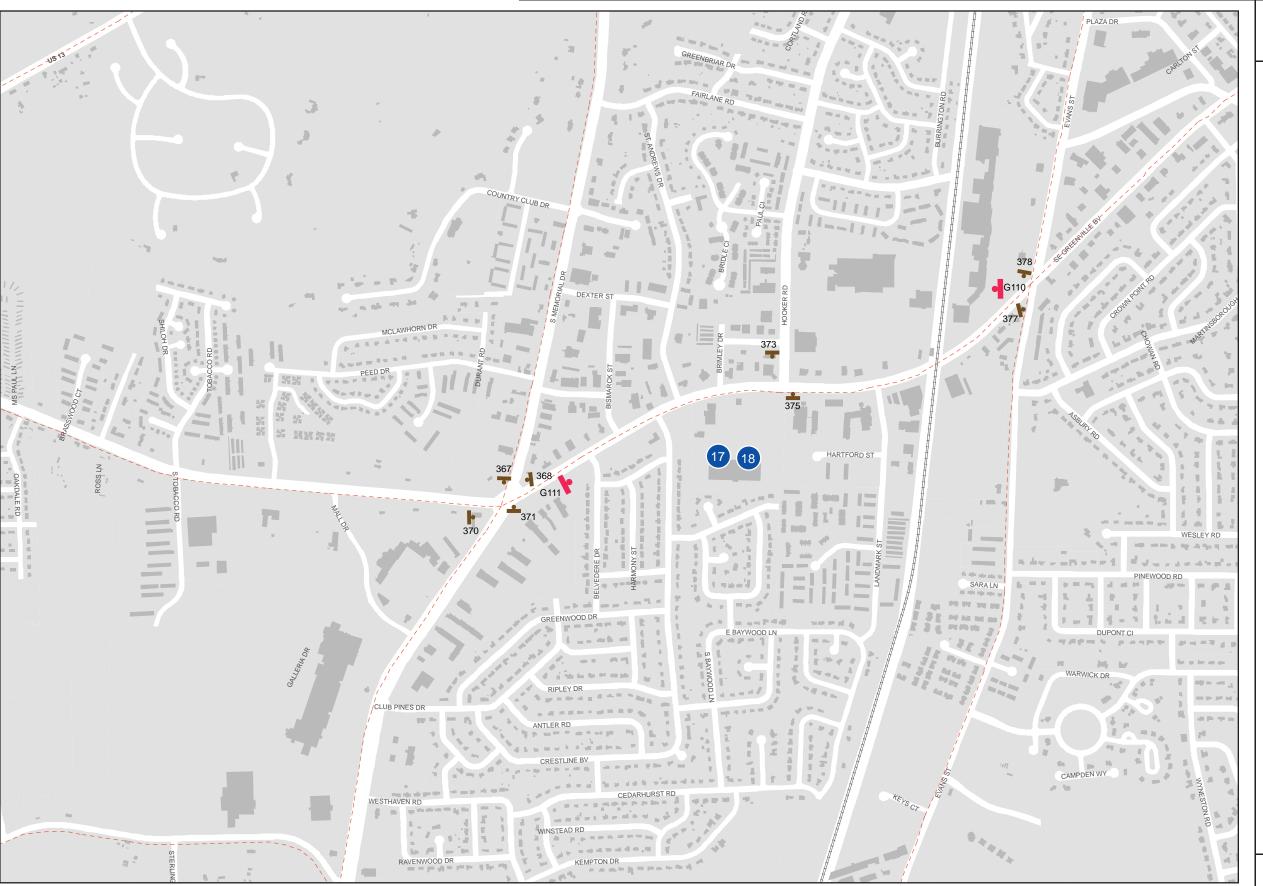

City of Greenville, NC Wayfinding Signing Program


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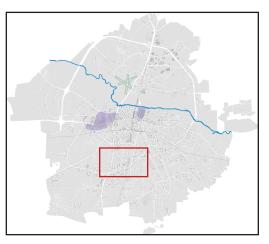
ECU Stadiums


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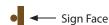
Pitt Comm College

Medical District


County Admin.

Convention

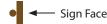State-Maintained Road

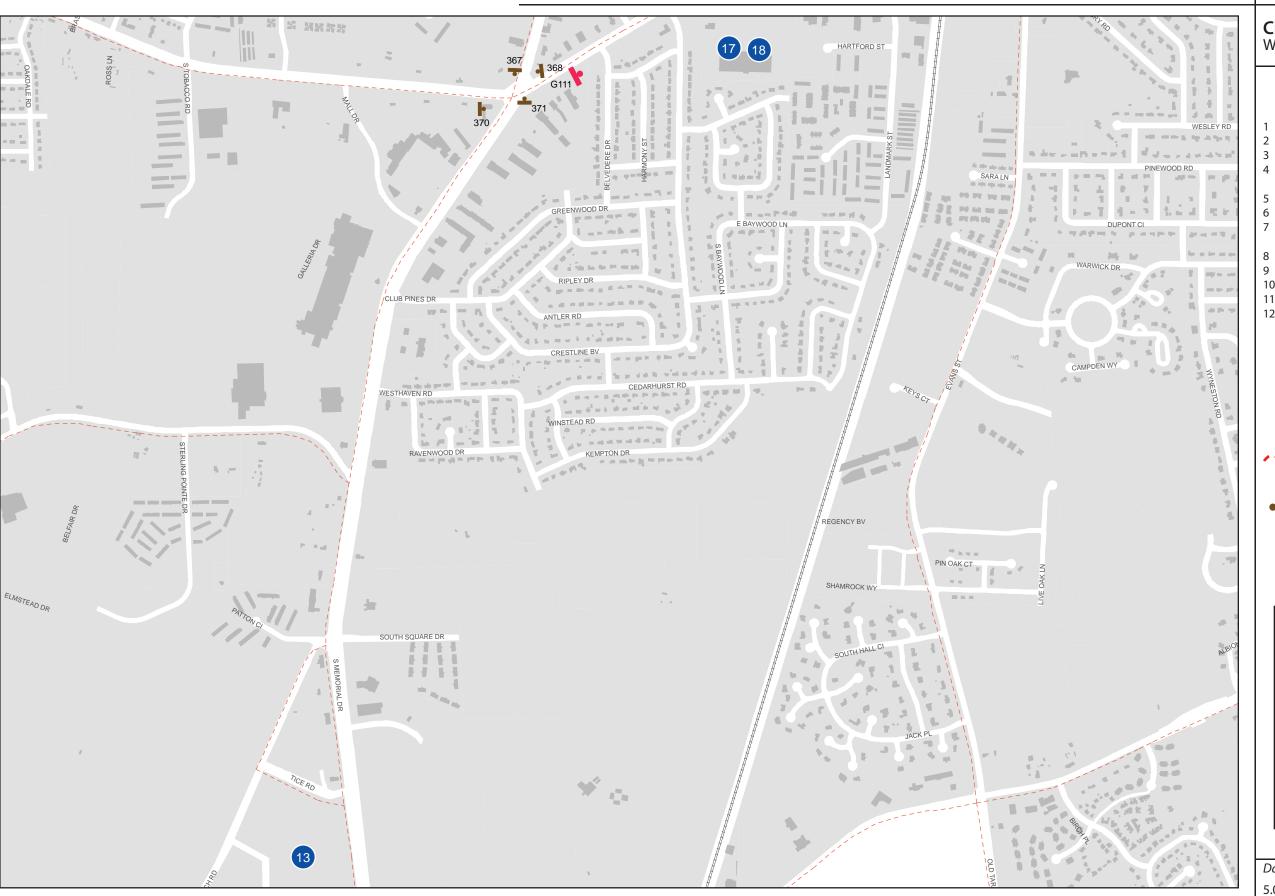

Key Map

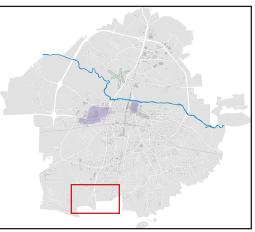

Sign Program - Future 10th St Connector



City of Greenville, NC Wayfinding Signing Program

NOTE: This page shows future signage work and is for informational purposes only. These signs are not part of the current bid package.

 Date
 Revisions

 5.01.08
 07.15.10

			SIGN DESCRIPTION - REG	ION			SIGN LOCATION			
District	Sign #	Sign Type	Face A	Face B	Orientation	Ground Condition	Reference Intersection	Sheet #	Remarks	
Uptown	101		REMOVED							
Uptown	102		REMOVED							
			← City Hall							
Uptown	103	VDIR.3	← Town Common		NB	Concrete	Evans @ Reade Circle	1		
			→ ECU Main Campus							
			↑ Sheppard Mem Library							
Uptown	104	VDIR.3	↑ Five Points Plaza		NB	Concrete	Evans @ Reade Circle	1		
•			↑ Courthouses				_			
			↑ Town Common							
Uptown	105	VDIR.3	→ ECU Main Campus		NB	Soil	Reade @ E 5th	1		
-			← City Hall							
Uptown	106	VDIR.2	个 City Hall		WB	Concrete	E 5th @ Reade	1		
Optown	100	V DIII Z	→ Town Common		, , ,	Concrete	L Still & Nedde	1 -		
Uptown	107	VDIR.1	↑ ECU Main Campus		EB	Concrete	E 5th @ Reade	1		
Ортомп	107	VDIK.1	·		LB	Concrete	L Still @ Reade	+	•	
			↑ City Hall							
Uptown	108	VDIR.3	← Museum of Art		WB	Concrete	E 5th @ Evans	1		
			→ Courthouses							
Uptown	109		REMOVED							
Uptown	110		REMOVED		ED.		WELL OF THE	1		
Uptown	111		ALREADY INSTALLED AS PROTOTYPE		EB		W 5th @ Evans		-	
Uptown	112	SERVICE.1	→ Airport		WB	Concrete	W 5th @ Greene	1		
			↑ Five Points Plaza							
Uptown	113	VDIR.3	← City Hall		NB	Concrete	Dickinson @ Reade Cir	1		
			→ ECU Main Campus							
			↑ Town Common			_				
Uptown	114	VDIR.2	→ Courthouses		NB	Concrete	Greene @ W 3rd	1		
Uptown	115		REMOVED							
			↑ Airport							
Uptown	116	VDIR.2	→ Town Common		NB	Concrete	Greene @ E 1st	1		
Lintarun	117	SERVICE.1	→ Airport		WB	Concrete	E 1st @ Greene	1		
Uptown	117	SERVICE.1	· · · · · · · · · · · · · · · · · · ·		VVB	Concrete	L 1st @ Greene	+ -		
Uptown	118	VDIR.2	↑ ECU Main Campus ← Town Common		SB	Soil	Pitt @ 1st	1		
			, , , , , , , , , , , , , , , , , , , ,							
			↑ ECU Main Campus							
Uptown	119	VDIR.3	← Chamber of Commerce		SB	Soil	Pitt @ 3rd	1		
			← Courthouses							
			← City Hall							
Uptown	120	VDIR.3	← Five Points Plaza		SB	Concrete	Pitt @ 5th	1		
			← ECU Main Campus							
			↑ City Hall		1			1		
Untown	121	VDIR.3	个 ECU Main Campus		EB	Soil	5th @ Pitt	1		
Uptown	121	כ.חוח א	→ Museum of Art		LD	3011	וארוו ש אווו	'	1	
	455									
Jptown	122		REMOVED							

City of Greenville, NC Wayfinding Signing Program

NOTE: Signs numbers with 'REMOVED' listing are not to be constructed and are not listed in the overall sign counts

Date Revisions

	SIGN DESCRIPTION - REGION						SIGN LOCATION		
District	Sign #	Sign Type	Face A	Face B	Orientation	Ground Condition	Reference Intersection	Sheet # Remarks	
Uptown	123	VDIR.3	↑ Town Common ← Courthouses → Museum of Art		ЕВ	Concrete	Reade Cir @ Evans	1	
Uptown	124	VDIR.3	↑ Museum of Art ↑ ECU Stadiums ← ECU Main Campus		SB	Concrete	Evans @ Reade Cir	1	
Uptown	125	VDIR.1	↑ ECU Main Campus		EB	Concrete	Reade Cir @ Cotanche	1	
Uptown	126	VDIR.2	← ECU Main Campus → Sheppard Mem Library		SB	Concrete	Cotanche @ Reade Cir	1	
Uptown	127	VDIR.2	↑ Courthouses ← City Hall		NB	Concrete	Evans @ E 5th	1	
Uptown	128		REMOVED					1	
Uptown	129		REMOVED						
Uptown	130	VDIR.1	← Courthouses		EB	Concrete	E 3rd @ Evans	1	
Uptown	131		REMOVED						
Uptown	132		REMOVED						
Uptown	133		REMOVED						
Uptown	134		REMOVED						
Uptown	135	VDIR.3	← City Hall → Town Common → ECU Main Campus		NB	Soil	Cotanche @ Reade Cir	1	
Uptown	136	VDIR.3	← Museum of Art→ Sheppard Mem Library→ Courthouses		WB	Concrete	Reade Cir @ Evans	1	
Uptown	137		REMOVED						
Uptown	138		REMOVED		-				
Uptown	139	VDIR.2	↑ Chamber of Commerce ↑ City Hall Parking		NB	Concrete	Greene @ 5th	1	
Uptown	140	VDIR.2	← Town Common ← Chamber of Commerce		NB	Concrete	5th @ Greene	1	
Citywide	301	VDIR.4	↑ Uptown District ↑ Medical District		ЕВ	Soil	Stantonsburg west of Allen	9	
Citywide	302	VDIR.4	→ ECU → Convention District		ЕВ	Soil	Stantonsburg @ Allen	9	
Citywide	303	VDIR.1B	→ Medical District		NB	Soil	Allen Rd @ Stantonsburg	9	
Uptown	304	VDIR.2B	← Uptown District ← Airport		ЕВ	Soil	Stantonsburg @ S Memorial	9	
Uptown	305	VDIR.2	← County Admin Office → Uptown District		NB	Soil	S Memorial @ W 5th	9	

City of Greenville, NC Wayfinding Signing Program

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Date Revisions

SIGN DESCRIPTION - REGION						SIGN LOCATION				
District	Sign #	Sign Type	Face A	Face B	Orientation	Ground Condition	Reference Intersection	Sheet #	Remarks	
itywide	306	VDIR.4	↑ Industrial Parks		SB	Soil	N Memorial south of Briley Dr	5		
Jptown	307	VDIR.1	→ G.W. Carver Branch Library		EB	Soil	W 5th @ Tyson St	10		
Citywide	308	VDIR.2B	← Detention Center ← County Office Complex		ЕВ	Soil	Pactolus/33 @ Old Creek Rd	7		
Citywide	309	VDIR.2B	← Detention Center ← County Office Complex		SB	Soil	N Greene @ Pactolus/33	7		
Jptown	310	VDIR.2	∇ Uptown District		ЕВ	Soil	W 5th @ Albemarle	10		
Citywide	311	VDIR.2B	✓ Detention Center✓ County Office Complex		NB	Soil	N Greene @ Pactolus/33	7		
Jptown	312	VDIR.2	↑ ECU Stadiums ← Uptown District		SB	Soil	S Memorial @ W 5th	9		
Citywide	313	VDIR.1B	→ Science and Nature Center		NB	Soil	N Memorial @ Airport	7		
Citywide	314	VDIR.3B	↑ Uptown District ↑ ECU Main Campus → ECU Stadiums		ЕВ	Soil	Airport @ N Memorial	7		
Citywide	315	VDIR.3B	↑ Detention Center ↑ County Office Complex → Science and Nature Center		NB	Soil	N Greene @ Mumford	7		
Jptown	316	VDIR.3B	↑ Uptown District ↑ ECU Main Campus ← Science and Nature Center		SB	Soil	N Greene @ Mumford	7		
Jptown	317	VDIR.3B	↑ Airport ← Uptown District ← ECU Main Campus		WB	Soil	Mumford @ N Greene	7		
Citywide	318	VDIR.1B	→ Science and Nature Center		EB	Soil	Mumford @ Tice Trailer	7		
itywide	319	VDIR.1B	← Science and Nature Center		WB	Soil	Mumford @ Tice Trailer	7		
Citywide	320	VDIR.3B	↑ ECU Stadiums ← Uptown District ← ECU Main Campus		SB	Soil	N Memorial @ Greenfield	6		
Citywide	321		REMOVED							
itywide	322		REMOVED							
Jptown	323	VDIR.2B	↑ Uptown District ↑ ECU		SB	Soil	N Memorial south of US 264 access	5		
Citywide	324	VDIR.1B	∇ Science and Nature Center		WB	Soil	Pactolus Hwy @ Mumford	8		
Citywide	325		REMOVED						İ	

City of Greenville, NC Wayfinding Signing Program

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Date Revisions

SIGN DESCRIPTION - REGION						SIGN LOCATION				
District	Sign #	Sign Type	Face A	Face B	Orientation	Ground Condition	Reference Intersection	Sheet #	Remarks	
Citywide	326		REMOVED							
Citywide	327	SERVICE.1	← Airport		NB	Soil	Alt US 264 @ US 264 & Pactolus	8		
Citywide	328	VDIR.3B	↑ Uptown District ← ECU Stadiums ← Convention District		WB	Soil	E 10th @ Greenville Blvd SE	13		
Citywide	329		REMOVED							
Jptown	330	VDIR.2	→ ECU Main Campus→ Uptown District		SB	Soil	Greenville Blvd SE @ E 10th	13		
Jptown	331	VDIR.2	↑ ECU Main Campus ↑ Uptown District		WB	Soil	E 10th @ E 5th	13		
Citywide	332	VDIR.1B	↑ ECU Stadiums		SB	Soil	Memorial Dr @ Dickinson	9		
Citywide	333	VDIR.2B	↑ Uptown District ← Medical District		EB	Soil	Dickinson Ave @ Memorial	9		
Citywide	334		REMOVED							
Jptown	335	VDIR.2	→ Uptown District→ Museum of Art		WB	Concrete	E 10th @ Evans	10		
Uptown	336	VDIR.3	↑ ECU Main Campus ← Museum of Art ← Uptown District		ЕВ	Soil	E 10th @ Evans	10		
Uptown	337	VDIR.3	↑ Uptown District ↑ Museum of Art → ECU Main Campus		NB	Soil	Evans @ E 10th	10		
Uptown	338	VDIR.2	↑ Convention District ↑ ECU Stadiums ← ECU Main Campus		SB	Soil	Evans @ E 10th	10		
Jptown	339	VDIR.1	☐ G.W. Carver Branch Library		NB	Soil	W 14th @ Farmville	10		
Jptown	340		REMOVED							
Jptown	341	VDIR.2	↑ Convention District ← ECU Stadiums		SB	Soil	Evans @ E 14th	10		
Citywide	342		REMOVED							
Citywide	343	VDIR.3B	↑ ECU Main Campus ↑ Uptown District → ECU Stadiums		NB	Soil	Evans @ E 14th	10		
Jptown	344	VDIR.3	← Uptown District← Museum of Art→ ECU Main Campus		NB	Soil	Charles @ E 10th	10		
Jptown	345	VDIR.2	→ Uptown District→ ECU Main Campus		WB	Soil	E 14th @ Charles	10		
Jptown	346		REMOVED							

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Date Revisions

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District	Sign #	Sign Type	Face A	Face B	Orientation	Ground Condition	Reference Intersection	Sheet #	Remarks		
Citywide	347	VDIR.3B	← Convention District → ECU Main Campus → Uptown District		WB	Soil	Ficklen Dr @ Charles	10			
Citywide	348		REMOVED								
Citywide	349		REMOVED								
Uptown	350	VDIR.1	↑ Medical District		WB	Soil	Stantonsburg @ Memorial	9			
Citywide	351		REMOVED								
Uptown	352	VDIR.1	← East Branch Library		EB	Soil	E 14th @ Laura	13			
Uptown	353	VDIR.1	→ East Branch Library		WB	Soil	E 14th @ Laura	13			
Uptown	354	VDIR.4	↑ Convention District		SB	Soil	Greenville SE @ E 14th	13			
Uptown	355		REMOVED								
Citywide	356	VDIR.1B	→ Convention District		SB	Soil	Charles @ Greenville SE	12			
Citywide	357	VDIR.4	↑ Convention District → ECU Stadiums		WB	Soil	Greenville SE @ Charles	12			
Citywide	358	VDIR.3B	↑ ECU ↑ Uptown District ← Con vention District		NB	Soil	Charles @ Greenville SE	12			
Citywide	359		REMOVED								
Citywide	360	VDIR.4	← ECU Stadiums		EB	Soil	Greenville SE @ Charles	12			
Citywide	361		REMOVED								
Uptown	362		REMOVED								
Citywide	363	VDIR.1B	↑ Convention District		SB	Soil	Evans @ W Arlington	12			
Uptown	364	VDIR.3B	↑ ECU Stadiums ↑ Uptown District ↑ Museum of Art		NB	Soil	Evans @ W Arlington	12			
Citywide	365	VDIR.4	↑ Convention District ↑ ECU		SB	Soil	Greenville SW @ US 13	11			
Citywide	366		REMOVED								
Citywide	367	VDIR.3B	↑ Pitt Comm College ← Convention Center ← ECU Stadiums		SB	Soil	S Memorial @ Greenville SW	14			
Citywide	368	VDIR.4	← Pitt Comm College → Medical District		WB	Soil	Greenville SW @ S Memorial	14			
Citywide	369		REMOVED								
Citywide	370	VDIR.4	↑ Convention District ↑ ECU → Pitt Comm College		EB	Soil	Greenville SW @ S Memorial	14			

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Date Revisions

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District	Sign #	Sign Type	Face A	Face B	Orientation	Ground Condition	Reference Intersection	Sheet #	Remarks		
Citywide	371	VDIR.3B	↑ Medical District → Convention District → ECU		NB	Soil	S Memorial @ Greenville SW	14			
Citywide	372		REMOVED								
Citywide	373	VDIR.2B	↑ Convention Center ↑ Visitor Center		SB	Soil	Hooker @ Greenville SW	14			
Citywide	374		REMOVED								
Citywide	375	VDIR.4	← Medical District → ECU → Uptown District		NB	Soil	Greenville SW @ Hooker	14			
Citywide	376		REMOVED								
Citywide	377	VDIR.4	↑ ECU Stadiums ← ECU Main Campus ← Uptown District		EB	Soil	Greenville SW @ Evans	12			
Citywide	378	VDIR.2B	← ECU Stadiums → Convention District		SB	Soil	Evans @ Greenville SW	12			
Citywide	379		REMOVED								
Citywide	380		REMOVED								
Citywide	381		REMOVED								
Citywide	382		REMOVED								
Citywide	383		REMOVED								
Citywide Citywide	384 385		REMOVED REMOVED								
Uptown	386	VDIR.1B	↑ Uptown District		EB	Soil	W 5th @ Memorial	9			
Citywide	387		REMOVED								
Uptown	388	SERVICE.1	→ Airport		WB	Soil	Farmville @ S Memorial	9			
Uptown	389	VDIR.1	← Medical District				S Memorial @ Stantonsburg	9			
Uptown	390	SERVICE.1	↑ Airport		ł		S Memorial north of RR tracks	9			
Citywide	391	SERVICE.1	REMOVED		110	3011	5 Wellional Horali of Alt tracks				
Uptown		VDIR.3	↑ Uptown District ↑ ECU Main Campus ← G.W. Carver Branch Library		NB	Soil	Dickinson @ W 14th	10			
Uptown	393	VDIR.2	→ Medical District→ G.W. Carver Branch Library		SB	Soil	Dickinson @ W 14th	10			
Uptown	394	VDIR.3	↑ Uptown District → Museum of Art → ECU Main Campus		NB	Soil	Dickinson @ W 10th	10			
Citywide	395		REMOVED								
Citywide	396	VDIR.2B	↑ Uptown District ← Medical District		NB	Soil	US 13 @ SW Greenville	11			

City of Greenville, NC Wayfinding Signing Program

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Date Revisions

SIGN DESCRIPTION - REGION							SIGN LOCATION			
District	Sign #	Sign Type	Face A	Face B	Orientation	Ground Condition	Reference Intersection	Sheet #	Remarks	
itywide	397	VDIR.2B	→ ECU → Convention District		NB	Soil	US 13 @ SW Greenville	11		
Jptown	398	VDIR.3B	↑ Science and Nature Center → Uptown District → ECU Main Campus		ЕВ	Soil	Airport @ N Greene	7		
itywide	399		REMOVED							
itywide	400		REMOVED							
itywide	401		REMOVED							
itywide itywide	402 403		REMOVED REMOVED		<u> </u>					
	404	SERVICE.1	→ Hospital		WB	Soil	Stantonsburg @ Moye	9		
itywide	<u> </u>							9		
itywide	405	SERVICE.1	→ Hospital		EB	Soil	W 5th @ Moye	9		
itywide	406	SERVICE.1	← Hospital		WB	Soil	W 5th @ Moye	9		
itywide	407		REMOVED							
Jptown	408	VDIR.4	↑ ECU Main Campus ↑ Uptown District → Science and Nature Center		SB	Soil	Greenville @ Pactolus Hwy	8		
itywide	409	VDIR.2B	↑ ECU Stadiums ↑Convention District		SB	Soil	Alt US 264 @ E 10th	13		
Jptown	410	VDIR.2	→ Medical District→ County Admin Office		SB	Soil	S Memorial @ W 5th	9		
Jptown	411	SERVICE.1	↑ Airport		NB	Soil	S Memorial @ E 5th St	9		
itywide	412	VDIR.2B	↑ ECU Stadiums ← Science and Nature Center		SB	Soil	N Memorial @ Airport	7		
itywide	413	VDIR.2B	↑ ECU Main Campus ↑ Uptown District		NB	Soil	Charles @ E 14th	10		
itywide	414		REMOVED							
itywide	415		REMOVED							
itywide	416		REMOVED							
itywide	417	VDIR.2B	↑ Uptown District ↑ ECU Main Campus		SB	Soil	N Greene @ Industrial Blvd	6		
itywide	418		REMOVED							
itywide	419		REMOVED							
itywide	420		REMOVED							
itywide	421		REMOVED							
itywide	422	SERVICE.1	← Airport		NB	Soil	N Memorial @ Airport	7		
itywide	423	SERVICE.1	← Airport		NB	Soil	N Greene @ Mumford	7		
itywide	424		REMOVED							

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District	Sign #	Sign Type	Face A	Face B	Orientation	Ground Condition	Reference Intersection	Sheet #	Remarks
Citywide	425	SERVICE.1	↑ Airport		SB	Soil	N Memorial @ US 264	5	
Citywide	426		REMOVED						
Citywide	427	VDIR.1B	→ Industrial Parks		WB	Soil	E 10th @ Greenville Blvd SE	13	
Citywide	428		REMOVED						
Citywide	429		REMOVED						
Citywide	430	SERVICE.1	← Airport		EB	Soil	W 5th @ Memorial	9	
Citywide	431		REMOVED						
Citywide	432		REMOVED						
Citywide	433		REMOVED						
Citywide	434	SERVICE.1	∧ Airport		WB	Soil	Pactolus Hwy @ Mumford	8	
Citywide	435	SERVICE.1	→ Airport		SB	Soil	N Memorial @ Airport	7	
Citywide	436		REMOVED						

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 Date
 Revisions

 11.18.08
 02.01.10 07.15.10

			SIGN DESCRIPTION - REG	ION			SIGN LOC	ATION	
District	Sign #	Sign Type	Face A	Face B	Orientation	Ground Condition	Reference Intersection	Sheet #	Remarks
Jptown	501	PARK.1	→ P		EB	Concrete	1st @ Washington	1	
Uptown	502	PARK.10	Public Parking Lot Uptown Shopping & Dining Mosely Lot 2 Hour Free Parking Leased Parking as Designated Monday - Friday 7:00am - 7:00 pm		SB	Concrete	4th St @ Moseley Lot	1	
Jptown	503	PARK.2	← P		WB	Existing Pole	1st @ Cotanche	1	
Jptown	504	PARK.2	→ P	← P	EB	Existing Pole	W 5th St @ Evans St Lot		
Jptown	505		ALREADY INSTALLED AS PROTOTYPE						
Jptown	506	PARK.3	P ← Public Parking		ЕВ	Concrete	3rd @ Evans	1	
Jptown	507	PARK.1	P 个 Public Parking		NB	Concrete	Evans St near 8th St 1		
Jptown	508	PARK.10	Public Parking Lot Greene Street Lot 2 Hour Free Parking Leased & Employee Parking as Designated Monday - Friday 7:00am - 7:00 pm		SB	Soil	Pitt St @ Greene St Lot	1	
Jptown	509	PARK.11	Public Parking Lot County and Federal Courthouses Courthouse Lot Leased Parking Only Monday - Friday 7:00 am - 7:00 pm	Public Parking Lot County and Federal Courthouses Courthouse Lot Leased Parking Only Monday - Friday 7:00 am - 7:00 pm	NB	Soil	Evans @ Texaco Lot	1	
Uptown	510	PARK.3	P ← Public Parking		NB	Concrete	Evans @ 4th	1	
Jptown	511	PARK.11	Public Parking Lot Uptown Shopping & Dining Blount Harvey Lot 2 Hour Free Parking Leased Parking as Designated Monday - Friday 7:00am - 7:00 pm	Public Parking Lot Uptown Shopping & Dining Blount Harvey Lot 2 Hour Free Parking Leased Parking as Designated Monday - Friday 7:00am - 7:00 pm	WB	Concrete	S Washington @ Blount Harvey Lot		
Jptown	512	PARK.11	Public Parking Lot Uptown Shopping & Dining Edwards Lot 2 Hour Free Parking Leased Parking as Designated Monday - Friday 7:00am - 7:00 pm	Public Parking Lot Uptown Shopping & Dining Edwards Lot 2 Hour Free Parking Leased Parking as Designated Monday - Friday 7:00am - 7:00 pm	NB	Concrete	NB Evans @ Edward Lot	1	

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District	Sign #	Sign Type	Face A	Face B	Orientation	Ground Condition	Reference Intersection	Sheet #	Remarks
Uptown	513	PARK.2	→ P		WB	Existing Pole	WB 5th @ Greene	1	
Uptown	514	PARK.3	P → Public Parking		NB	Concrete	Greene @ 4th	1	
Uptown	515		REMOVED						
Uptown	516	PARK.10	Public Parking Lot Dickinson Lot 2 Hour Free Parking	Public Parking Lot Dickinson Lot 2 Hour Free Parking	NB	Concrete	Dickinson @ Dickinson Ave Lot		
Uptown	517		REMOVED						
Uptown	518	PARK.10	Public Parking Lot Georgetown Lot Metered Parking Monday - Friday 8:00 am - 5:00 pm Note Space # - Pay At Pay Station		NB	Concrete	Reade St @ Georgetown Lot	1	
Uptown	519	PARK.11	Public Parking Lot Uptown Shopping & Dining Harris Lot 2 Hour Free Parking Leased Parking as Designated Monday - Friday 7:00am - 7:00 pm	Public Parking Lot Uptown Shopping & Dining Harris Lot 2 Hour Free Parking Leased Parking as Designated Monday - Friday 7:00am - 7:00 pm	SB	Concrete	Cotanche @ Harris	1	If possible, locate this sign so as to be seen on 4th St as well as Cotanche
Uptown	520	PARK.11	Public Parking Lot Uptown Shopping & Dining Five Points Plaza 2 Hour Free Parking Leased Parking as Designated Monday - Friday 7:00am - 7:00 pm	Public Parking Lot Uptown Shopping & Dining Five Points Plaza 2 Hour Free Parking Leased Parking as Designated Monday - Friday 7:00am - 7:00 pm	NB	Soil	Evans St @ Five Points Plaza		
Uptown	521	PARK.11	Public Parking Lot Uptown Shopping & Dining Roses Lot 2 Hour Free Parking	Public Parking Lot Uptown Shopping & Dining Roses Lot 2 Hour Free Parking	WB	Concrete	E 4th St @ Roses Lot	1	
Uptown	522	PARK.10	Public Parking Lot Uptown Shopping & Dining Merchant Lot 2 HR Free Parking Leased Parking as Designated Monday - Friday 7:00 am - 7:00 pm	Public Parking Lot Uptown Shopping & Dining Merchant Lot 2 HR Free Parking Leased Parking as Designated Monday - Friday 7:00 am - 7:00 pm	NB	Concrete	S Washington @ Merchant Lot		

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District	Sign #	Sign Type	Face A	Face B	Orientation	Ground Condition	Reference Intersection	Sheet #	Remarks	
Uptown	523	PARK.11	Public Parking Lot Greene Street Lot 2 Hour Free Parking Leased & Employee Parking as Designated Monday - Friday 7:00am - 7:00 pm	Public Parking Lot Greene Street Lot 2 Hour Free Parking Leased & Employee Parking as Designated Monday - Friday 7:00am - 7:00 pm	ЕВ	soil	W 4th St @ Greene St Lot	1		
Uptown	524	PARK.10	Public Parking Lot Uptown Shopping & Dining Hodges Lot Metered Parking Monday - Friday 8:00 am - 5:00 pm Note Space # - Pay At Pay Station		NB	Soil Reade St @ Hodges Lot		1		
Uptown	525	PARK.2	← P		SB	Existing Pole	Cotanche @ Georgetown Lot	1		
Uptown	526		REMOVED							
Uptown	527	PARK.10	Public Parking Reade Street Loading Zone Where Marked Metered Parking Monday - Friday 8:00 am - 5:00 pm Note Space # - Pay At Pay Station			Soil	Reade St between Cotanche & 5th	1		
Uptown	528	PARK.11	Public Parking Lot Uptown Shopping & Dining Five Points Plaza 2 Hour Free Parking Leased Parking as Designated Monday - Friday 7:00am - 7:00 pm	Public Parking Lot Uptown Shopping & Dining Five Points Plaza 2 Hour Free Parking Leased Parking as Designated Monday - Friday 7:00am - 7:00 pm	ЕВ	Concrete	Dickinson Ext @ Evans	1		

City of Greenville, NC Wayfinding Signing Program

NOTE: Signs numbers with 'REMOVED' listing are not to be constructed and are not listed in the overall sign counts

	SIGN DESCRIPTION - REGION						SIGN LOCATION			
District	istrict Sign # Sign Type Face A Face B Orientation		Ground Condition	Reference Intersection	Sheet #	Remarks				
Uptown	601	PED.1	个 ECU Main Campus ↑ Museum of Art ↑ Courthouses ↑ City Hall	个 Town Common	SB	Concrete	E 1st St @ Evans St	2		
Uptown	602		REMOVED							
Uptown	603		REMOVED							
Uptown	604	PED.1B	↑ Town Common ↑ ECU Main Campus ↑ Museum of Art ↑ Courthouses	个 Chamber of Commerce	ЕВ	Existing Pole	W 3rd St @ Greene St	2		
Uptown	605	PED.1B	← Town Common→ ECU Main Campus→ Museum of Art	→ Town Common← ECU Main Campus← Museum of Art	ЕВ	Existing Pole	W 3rd St @ Evans St	2		
Uptown	606	PED.1	↑ Town Common ← Chamber of Commerce	↑ ECU Main Campus ↑ Museum of Art → Chamber of Commerce	NB	Concrete	Evans St @ W 3rd St	2		
Uptown	607	PED.1	↑ Town Common ← Chamber of Commerce	↑ ECU Main Campus ↑ Museum of Art → Chamber of Commerce	NB	Concrete	Evans St @ E 3rd St	2		
Uptown	608	PED.1	↑ Town Center ← Courthouses	↑ ECU Main Campus → Courthouses	NB	Concrete	Reade St @ E 3rd St	2		
Uptown	609	PED.1B	← ECU Main Campus	→ ECU Main Campus	SB	Existing Pole	Reade St @ E 5th St	2		
Uptown	610	PED.1	 ← Town Common ← Courthouses ← Chamber of Commerce → ECU Main Campus → Museum of Art 	 ← ECU Main Campus ← Museum of Art → Town Common → Courthouses → Chamber of Commerce 	EB	Concrete	W 4th St @ Evans St	2		
Uptown	611		REMOVED							
Uptown	612		REMOVED							
Uptown	613		REMOVED							
Uptown	614	PED.1B	↑ Town Common ↑ ECU Main Campus ↑ Museum of Art ↑ Library	↑ City Hall	ЕВ	Existing Pole	W 5th St @ Washington St	2		
Uptown	615	PED.1	↑ ECU Main Campus ← Town Common → Museum of Art → Library	↑ City Hall ← Museum of Art ← Library → Town Common	EB	Concrete	W 5th St @ Evans St	2		

City of Greenville, NC Wayfinding Signing Program

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			SIGN DESCRIPTION	I - REGION			SIGN LOCATION			
District	Sign #	Sign Type	Face A	Face B	Orientation	Ground Condition	Reference Intersection	Sheet #	Remarks	
Uptown	616	PED.1	↑ Museum of Art ↑ Five Points Plaza ↑ Library ← ECU Main Campus → City Hall	↑ Town Common ← City Hall → ECU Main Campus	SB	Concrete	Evans St @ W 5th St	2	2	
Jptown	617		REMOVED							
Jptown	618		REMOVED							
Uptown	619		REMOVED							
Jptown	620		REMOVED							
Uptown	621	PED.1	↑ City Hall ← Library ← Five Points Plaza → Town Common → Courthouses	↑ ECU Main Campus ← Courthouses	WB	Concrete	Evans St @ E 5th St	2	2	
Jptown	622		REMOVED							
Jptown	623		REMOVED							
Uptown	624	PED.1	→ ECU Main Campus	← ECU Main Campus	NB	Concrete	E 5th St @ Reade St	2	2	
Uptown	625	PED.1	← Uptown District	→ Uptown District	NB	Soil	E 5th St @ Holly St	2	2	
Uptown	626		REMOVED							
Jptown	627		REMOVED							
Jptown	628		REMOVED							
Uptown	629	PED.1B	→ ECU Main Campus ↑ Town Common ↑ Amphitheater ↑ Library ↑ City Hall	← ECU Main Campus	NB	Existing Pole	Evans St @ Reade Cir	2	2	
Uptown	630	PED.1B	↑ Museum of Art	→ ECU Main Campus ↑ Town Common ↑ Library ↑ City Hall	SB	Existing Pole	Evans St @ Reade Cir	2	2	
Jptown	631		REMOVED							
Jptown	701		REMOVED							
Jptown	702		REMOVED							
Jptown	703		REMOVED							
Jptown	704		REMOVED							
Jptown	705		REMOVED							
Uptown	706	KIOSK.2			NB	Concrete	Evans St @ E 5th St	2	2	
Jptown	707		REMOVED							
Jptown	708		REMOVED							
Jptown	709		REMOVED							
Jptown	710		REMOVED							

City of Greenville, NC Wayfinding Signing Program

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Date Revisions

			SIGN DESCRIPTION - REGI	ON			SIGN LOCA	TION	
District	Sign #	Sign Type	Face A	Face B	Orientation	Ground Condition	Reference Intersection	Sheet #	Remarks
Uptown	G101	DISTGATE.2	Uptown District		SB	Soil	N Pitt St @ First St	3	Gateways to be listed as alternates
Uptown	G102	DISTGATE.2	Uptown District		WB	Soil	E 1st St east of Reade St	3	Gateways to be listed as alternates
Uptown	G103	DISTGATE.2	Uptown District		ЕВ	Soil	W Fifth St west of Pitt St	3	Gateways to be listed as alternates
Uptown	G104	DISTGATE.2	Uptown District		WB	Soil	E 5th St east of Reade St		Gateways to be listed as alternates
Uptown	G105	DISTGATE.2	Uptown District		NB	Concrete	Evans St south of 9th St	3	Gateways to be listed as alternates
Citywide	G106	DISTGATE.2	Medical District		ЕВ	Soil	W 5th St east of B's Barbecue Rd	9	Gateways to be listed as alternates
Citywide	G107	DISTGATE.2	Medical District		ЕВ	Soil	Stantonsburg Rd east of Allen Rd	9	Gateways to be listed as alternates
Citywide	G108	DISTGATE.2	Medical District		WB	Soil	W 5th St west of Memorial Dr	9	Gateways to be listed as alternates
Citywide	G109	DISTGATE.2	Medical District		WB	Soil	Stantonsburg Rd west of Memorial Dr		Gateways to be listed as alternates
Citywide	G110	DISTGATE.2	Convention District		WB	Soil	SE Greenville Blvd near Evans St	12	Gateways to be listed as alternates
Citywide	G111	DISTGATE.2	Convention District		ЕВ	Soil	SE Greenville Blvd east of Memorial Dr	14	Gateways to be listed as alternates

City of Greenville, NC Wayfinding Signing Program

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Message Schedule - 10th St Connector

		SIGN	DESCRIPTION - REGION				SIGN LOCATION			
District	Sign #	Sign Type	Face A	Face B	Orientation	QTY	Reference Intersection	Sheet #	Remarks	
10th St Conn	1001	VDIR.3	↑ Uptown District ↑ Medical District ↑ ECU		ЕВ		Stantonsburg @ Allen		Replace 301	
10th St Conn	1002	VDIR.2	↑ Uptown District ↑ ECU		EB		Stantonsburg @ Memorial		Replace 304	
10th St Conn	1003	VDIR.3	← Hospital→ ECU→ Uptown District		NB		S Memorial @ Stantonsburg		Replace 389	
10th St Conn	1004	VDIR.3	↑ ECU ← Uptown District ← Thomas Foreman Park		SB		S Memorial @ W 5th		Replace 312	
10th St Conn	1005	VDIR.1	← ECU		SB		Stantonsburg @ Memorial			
10th St Conn	1006	VDIR.2	↑ ECU ← Uptown District → Convention District		EB		10th St @ Evans		Same as 336	
10th St Conn	1007	VDIR.2	↑ Medical District → Uptown District		WB		E 10th @ Evans		Replace 335	
10th St Conn	1008	VDIR.3	↑ Convention District ← ECU → Medical District		SB		Evans @ E 10th		Replace 338	
10th St Conn	1009	VDIR.3	↑ Uptown District ← Medical District → ECU		NB		Evans @ E 10th		Replace 337	
10th St Conn	1010	VDIR.2	↑ ECU Main Campus → ECU Stadiums		ЕВ		10th St @ Charles			

City of Greenville, NC Wayfinding Signing Program

NOTE: This page shows future signage work and is for informational purposes only. These signs are not part of the current bid package.

Message Schedule - Sign Count

UPTOWN DISTRICT

Cian Tyno	Groun	d Conditio	n	
Sign Type	Concrete	Soil	Pole	
PED.1	9	1	0	
PED.1B	6	0	6	
VDIR.1	3	6	0	
VDIR.1B	0	1	0	
VDIR.2	8	11	0	
VDIR.2B	0	2	0	
VDIR.3	8	9	0	
VDIR.3B	0	4	0	
VDIR.4	0	2	0	
Park.1	2	0	0	
Park.2	4	0	4	
Park.3	3	0	0	
Park.10	4	3	0	
Park.11	5	3	0	
Kiosk.2	1	0	0	
Service.1	2	3	0	
GATE.1	0	0	0	
Dist.Gate.2	1	4	0	
Subtotal	46	49	10	
TOTAL		105		

CITYWIDE

Ciana Truma	Groui	nd Condit	ion
Sign Type	Concrete	Soil	Pole
PED.1	0	0	0
PED.1B	0	0	0
VDIR.1	0	0	0
VDIR.1B	0	9	0
VDIR.2	0	0	0
VDIR.2B	0	12	0
VDIR.3	0	0	0
VDIR.3B	0	9	0
VDIR.4	0	10	0
Park.1	0	0	0
Park.2	0	0	0
Park.3	0	0	0
Park.10	0	0	0
Park.11	0	0	0
Kiosk.2	0	0	0
Service.1	0	10	0
GATE.1	0	1	0
Dist.Gate.2	0	6	0
Subtotal	0	57	0
TOTAL		57	


TOTAL PROGRAM

Cian Tuna	Gre	ound Cor	ndition				
Sign Type	Concrete	Soil	Pole				
PED.1	9	1	0				
PED.1B	6	0	6				
VDIR.1	3	6	0				
VDIR.1B	0	10	0				
VDIR.2	8	11	0				
VDIR.2B	0	14	0				
VDIR.3	8	9	0				
VDIR.3B	0	13	0				
VDIR.4	0	12	0				
Park.1	2	0	0				
Park.2	4	0	4				
Park.3	3	0	0				
Park.10	4	3	0				
Park.11	5	3	0				
Kiosk.2	1	0	0				
Service.1	2	13	0				
GATE.1	0	1	0				
Dist.Gate.2	1	10	0				
Subtotal	46	106	10				
TOTAL		162					


City of Greenville, NC Wayfinding Signing Program

Date Revisions

Removal Plan

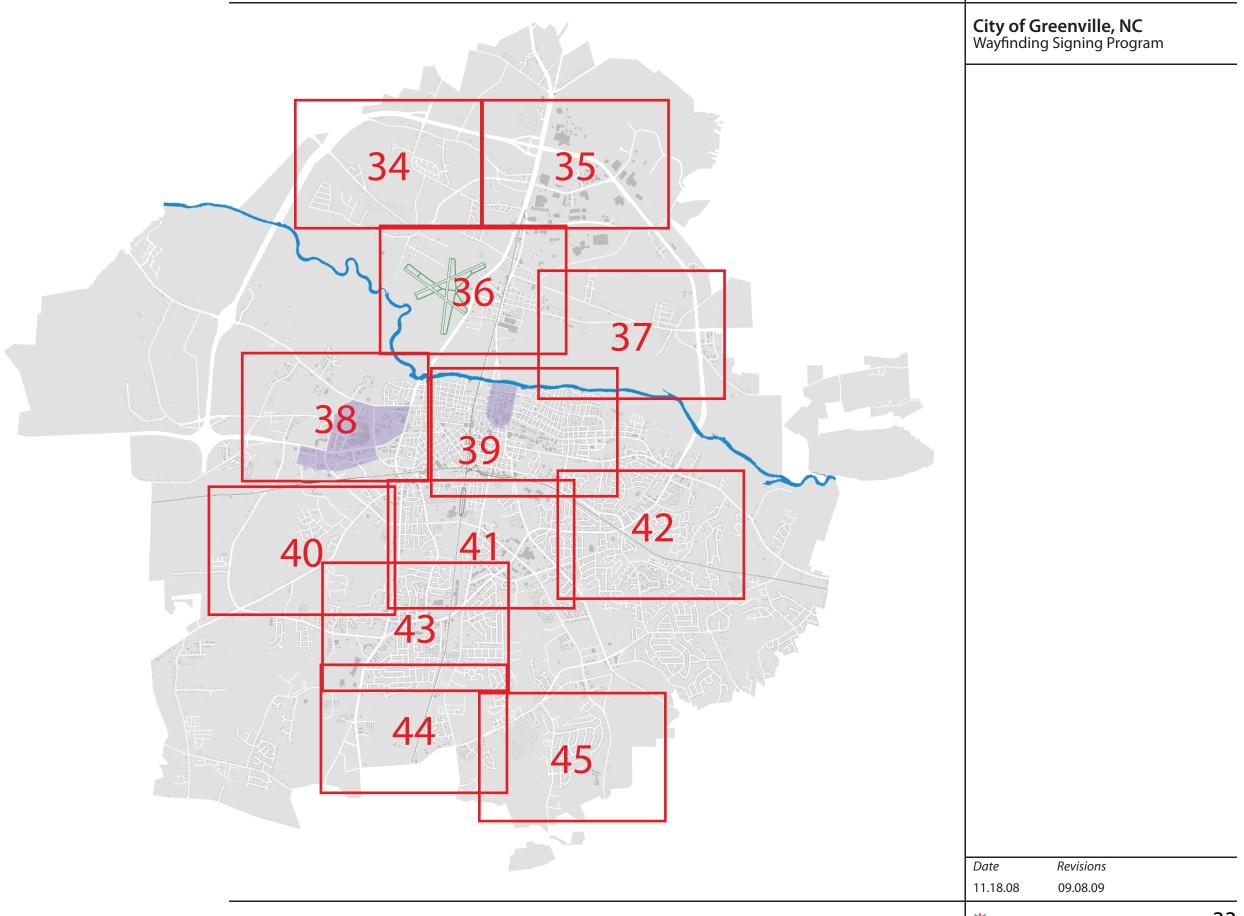



Removal Plan

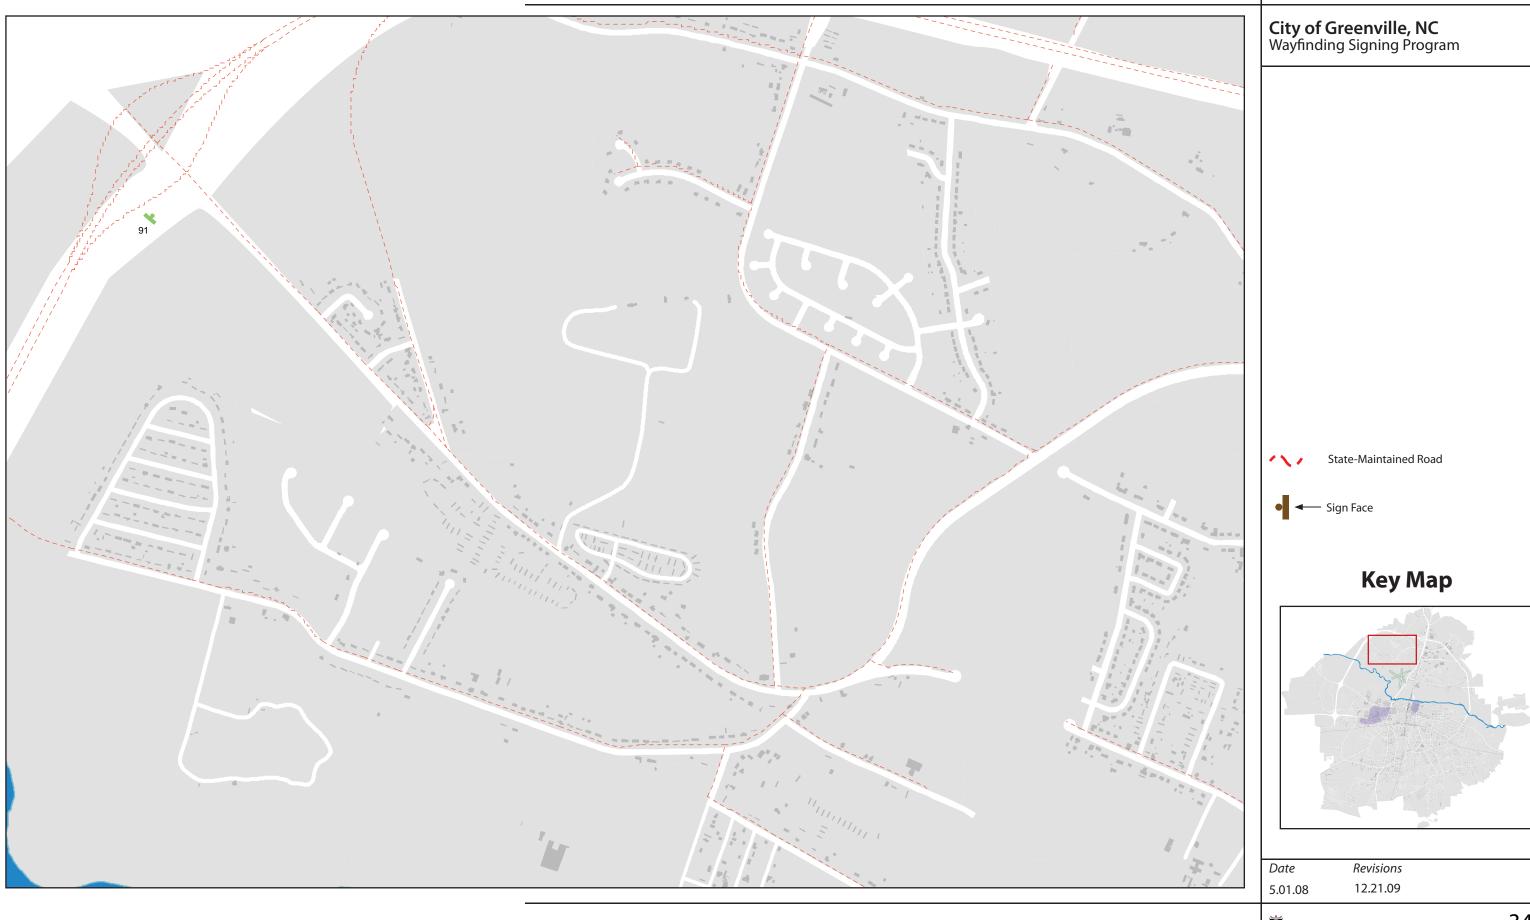

Removal Plan



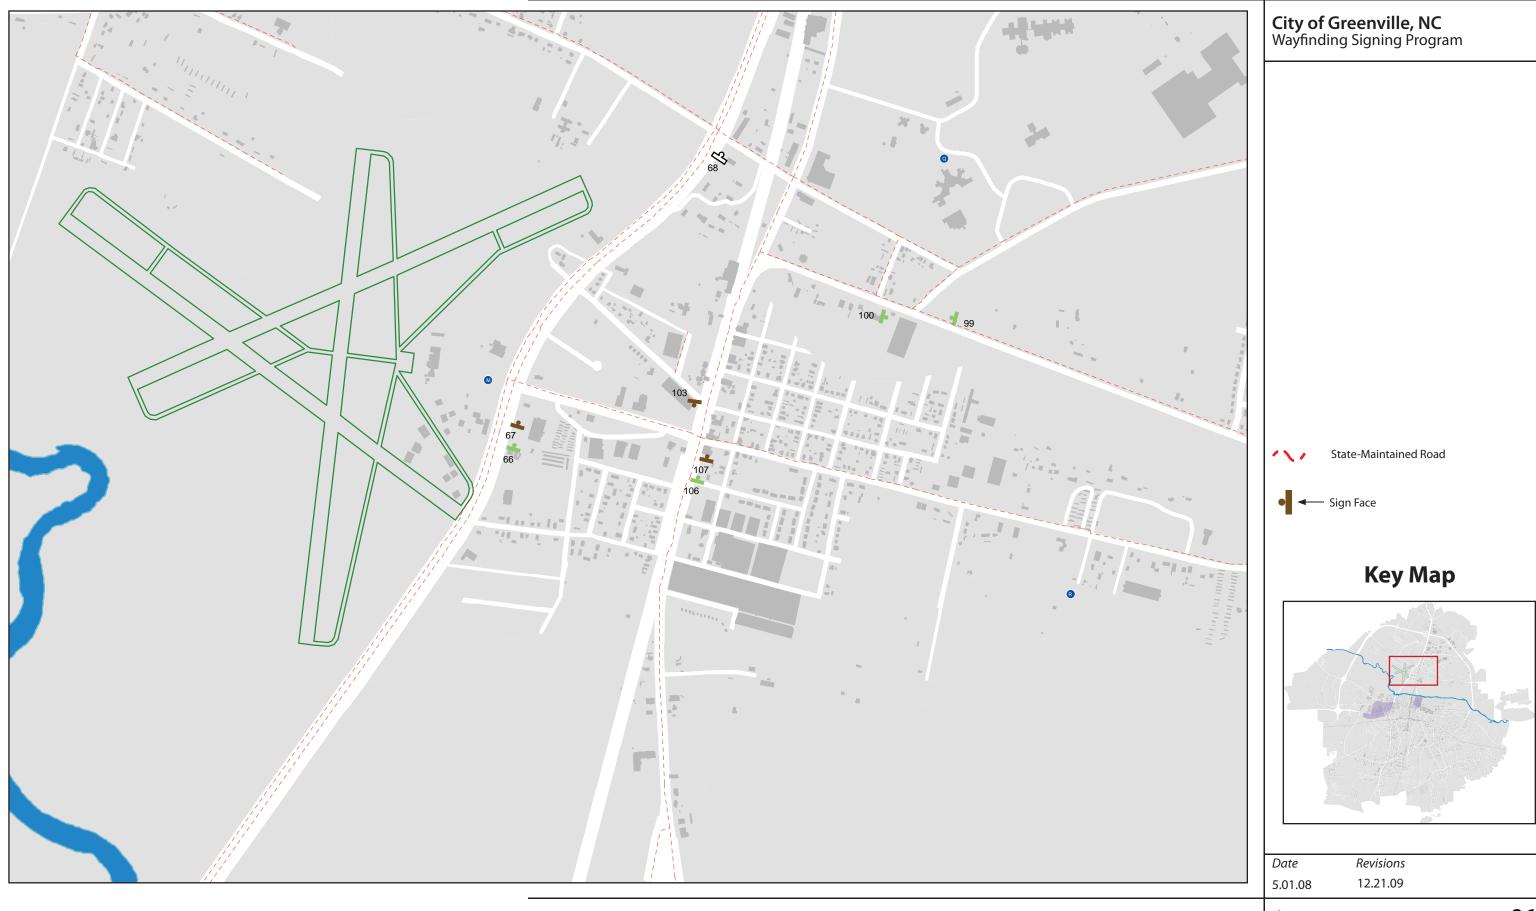

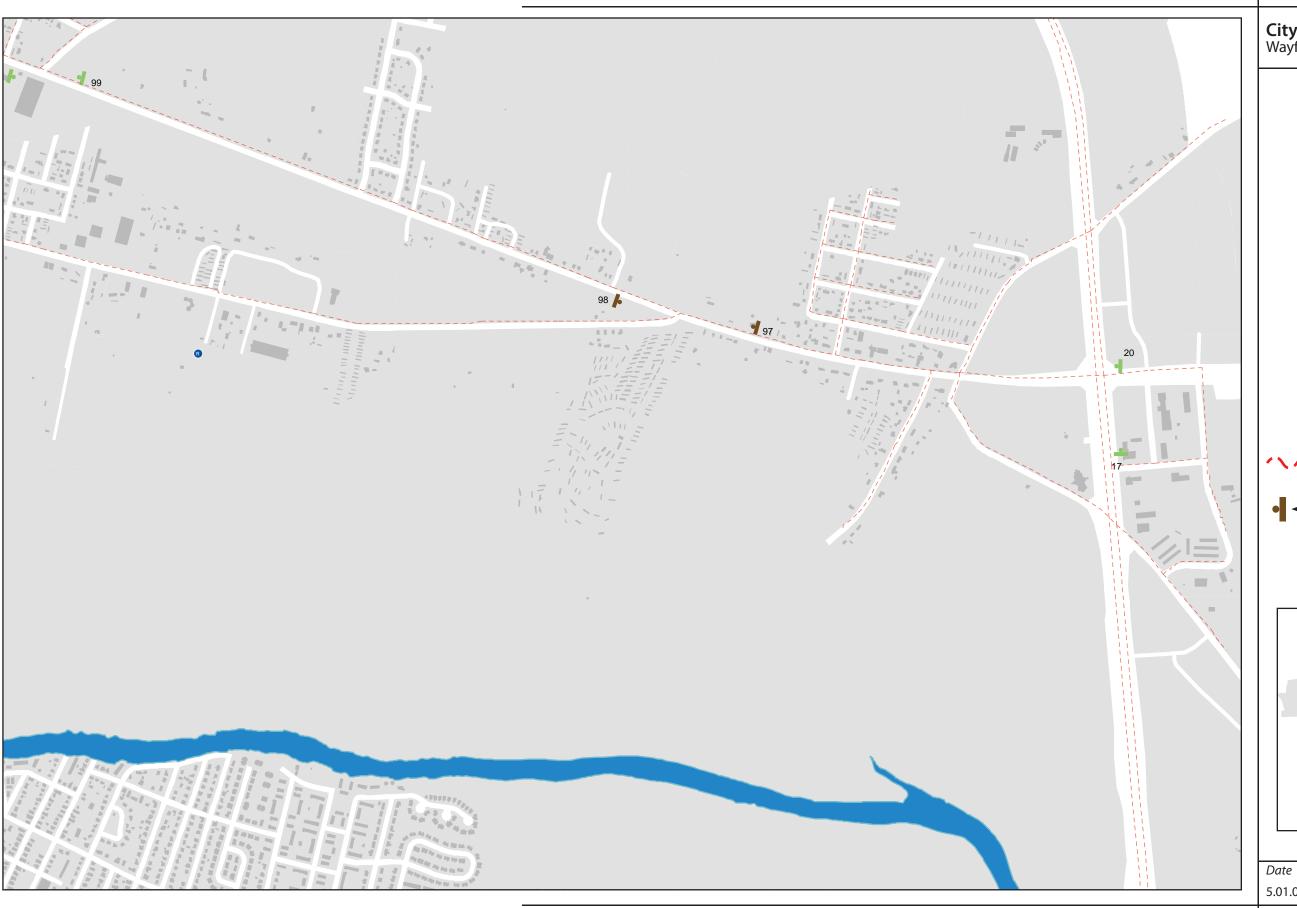


City of Greenville, NC Wayfinding Signing Program




State-Maintained Road




Key Map

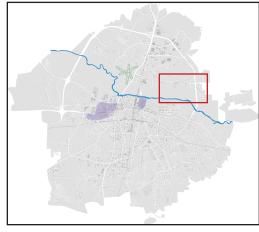

Revisions 5.01.08 12.21.09

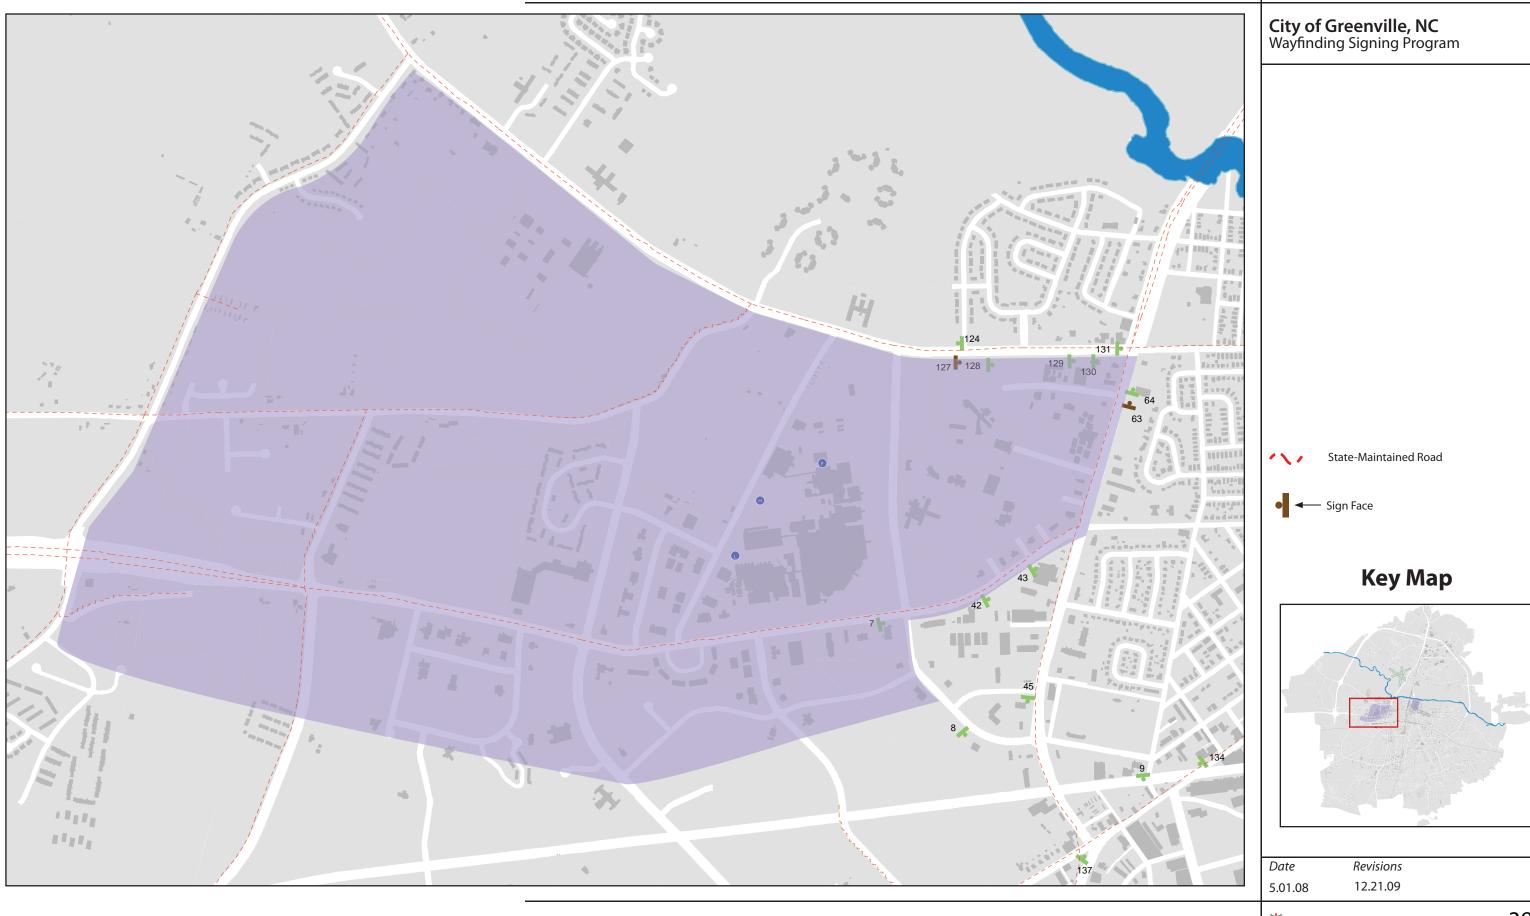

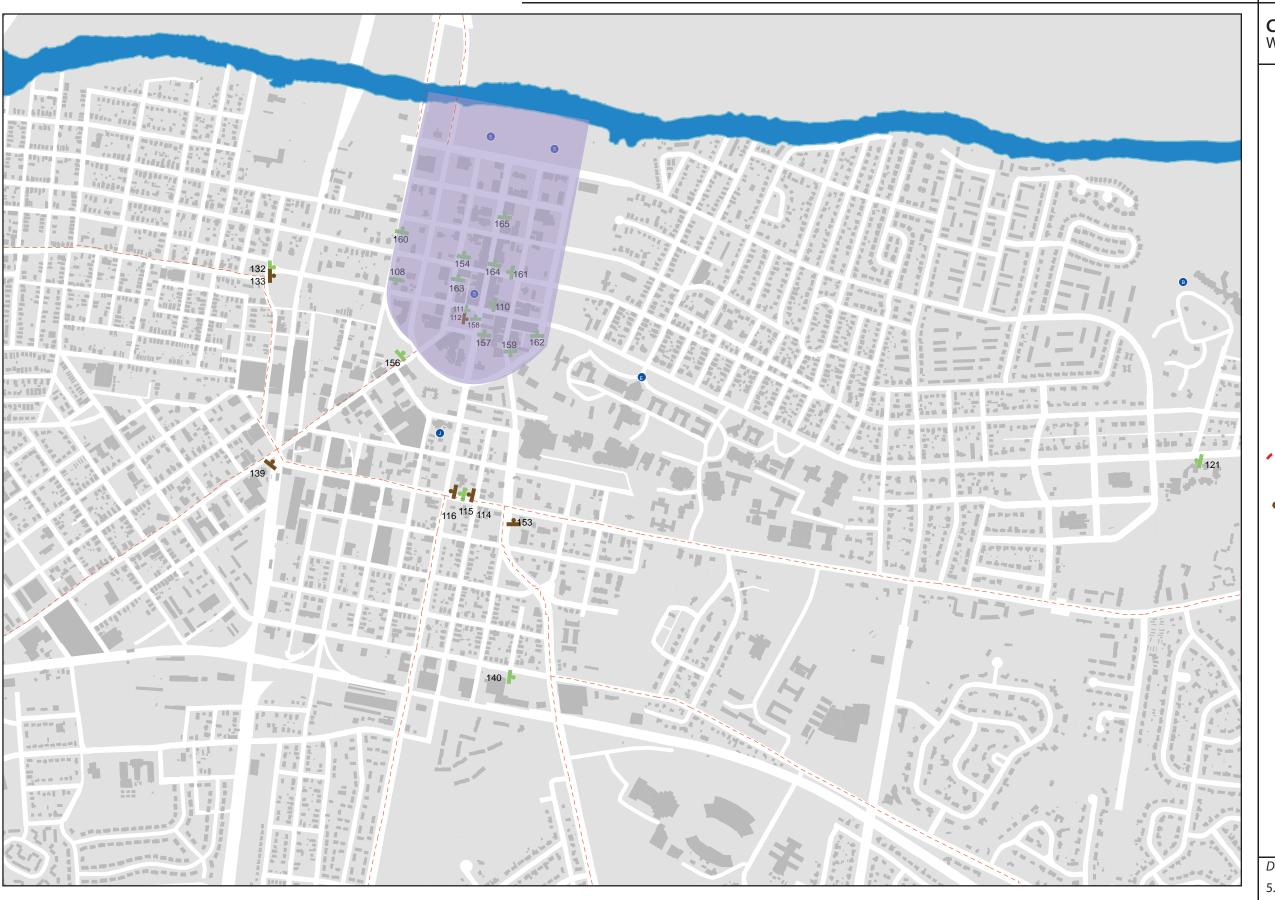


City of Greenville, NC Wayfinding Signing Program

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State-Maintained Road


● **←** Sign Fa


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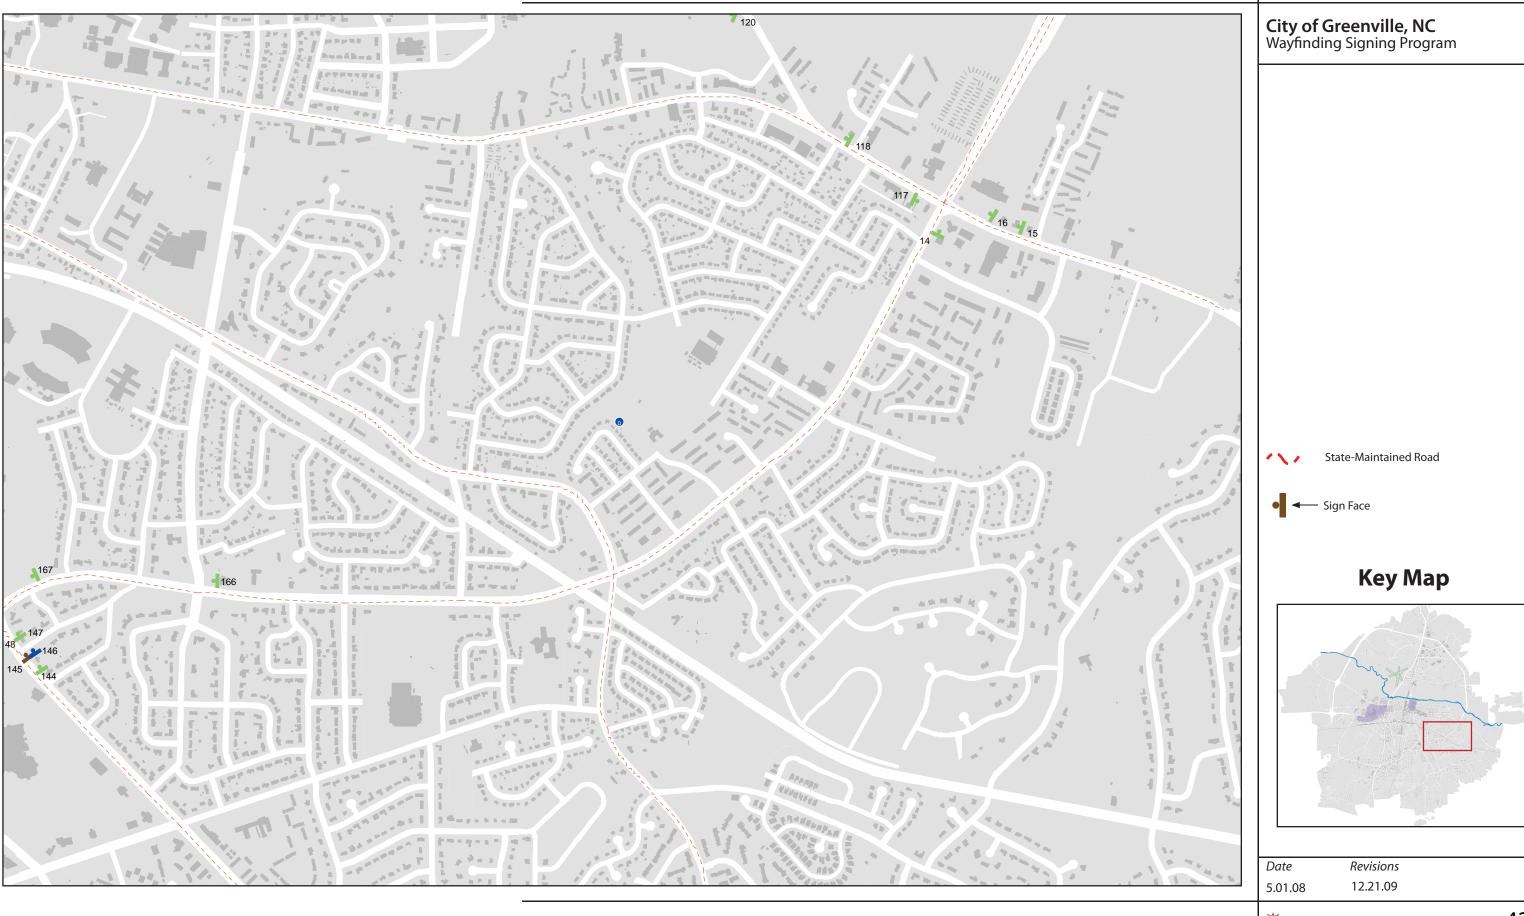



 Date
 Revisions

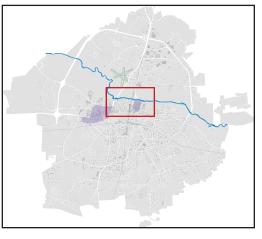 5.01.08
 12.21.09



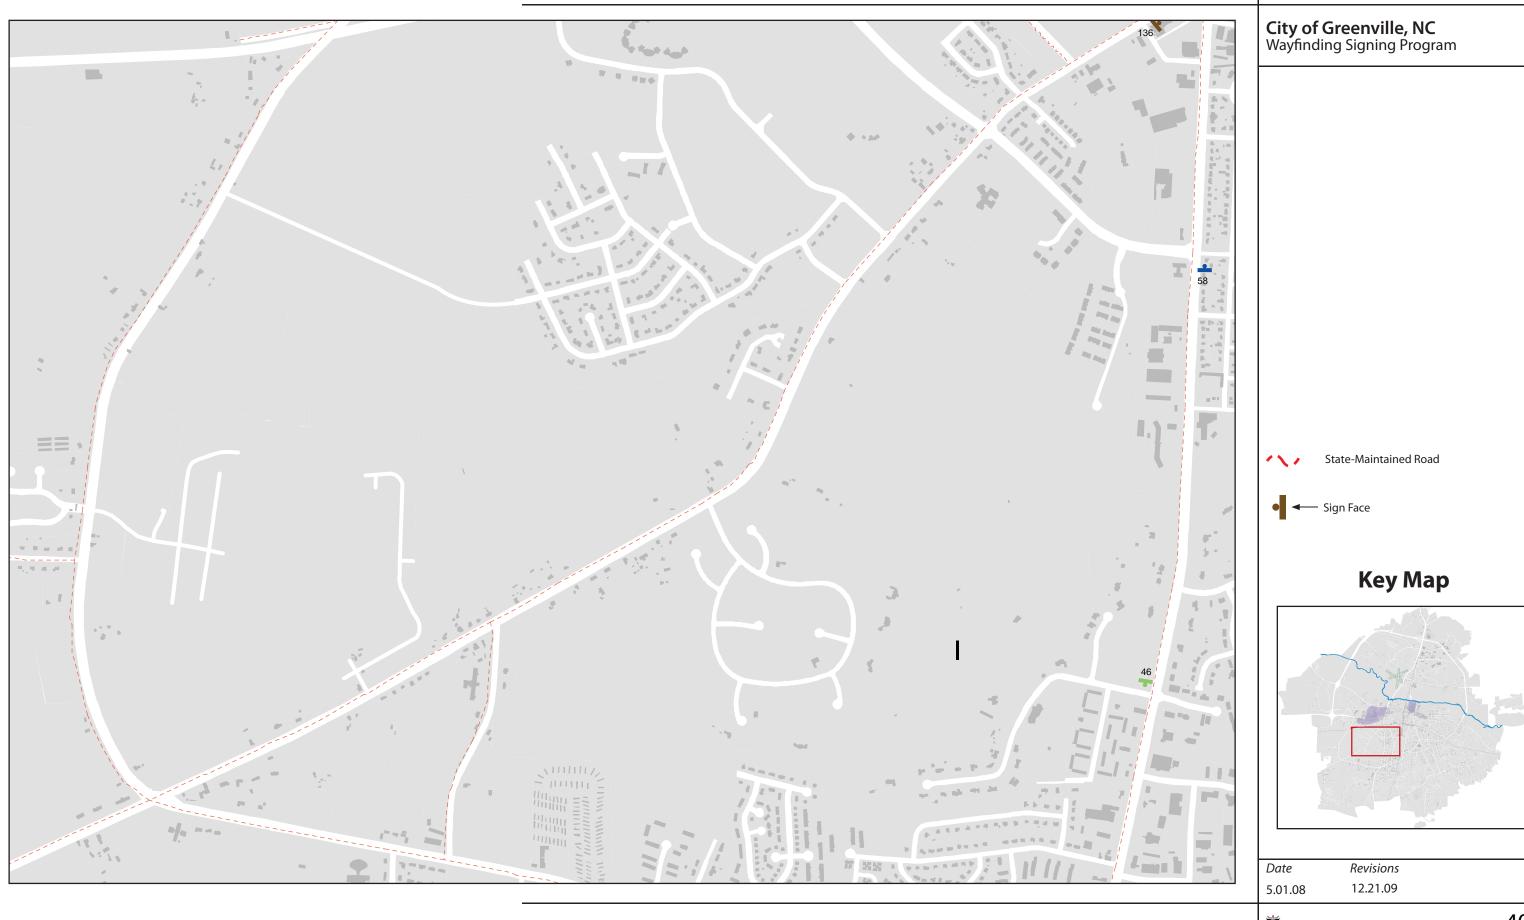

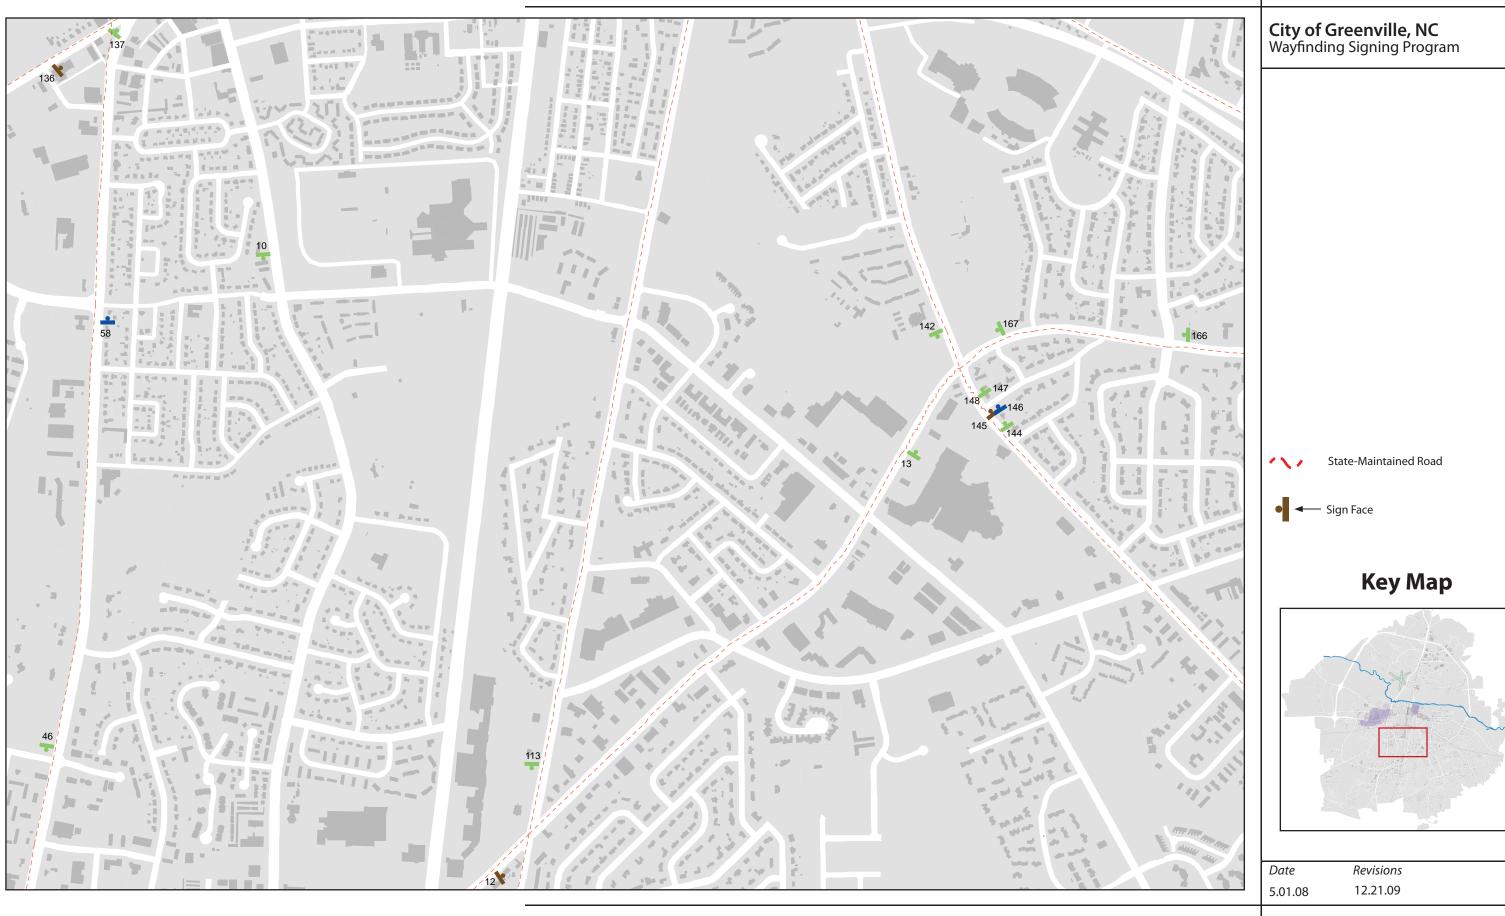


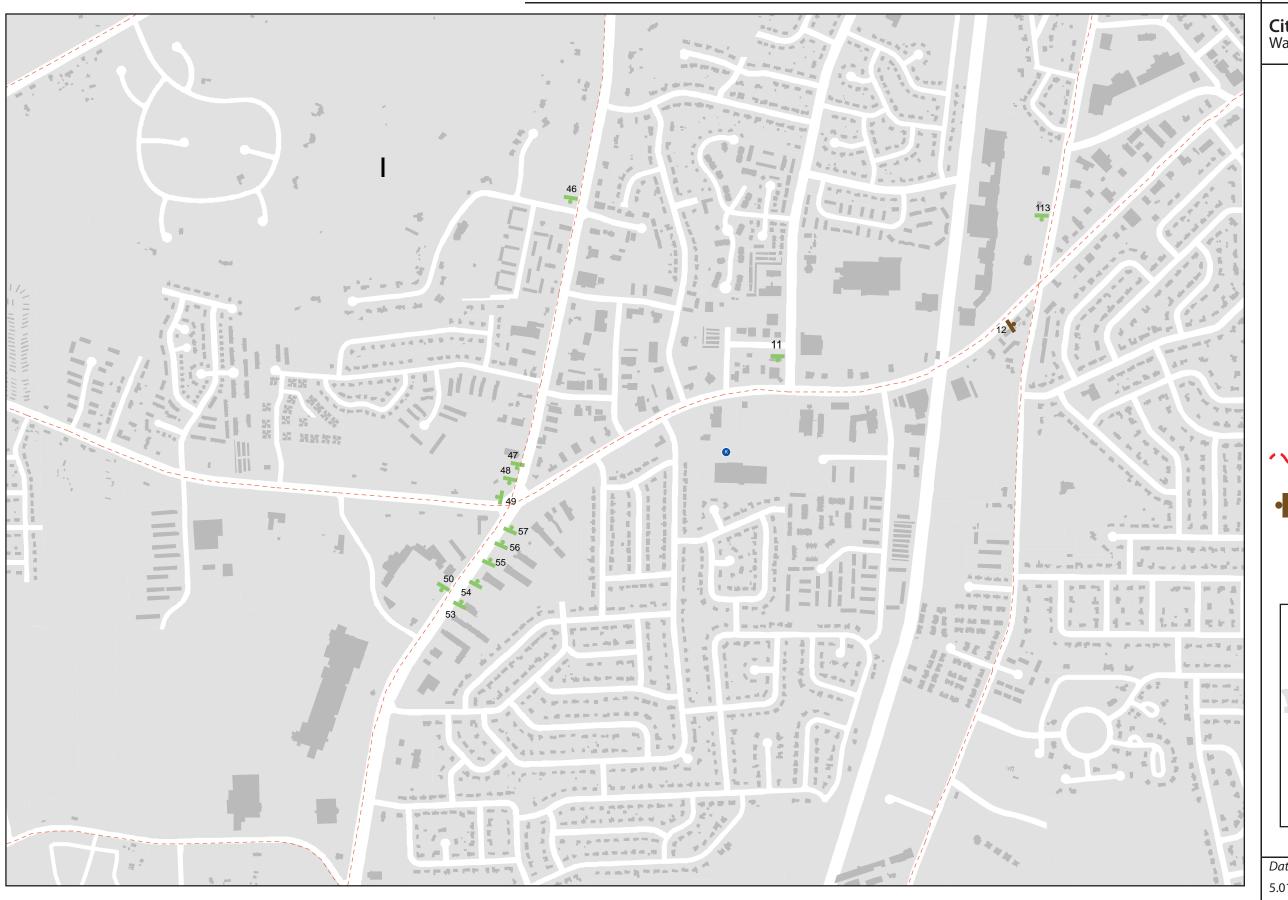


City of Greenville, NC Wayfinding Signing Program

State-Maintained Road

Key Map

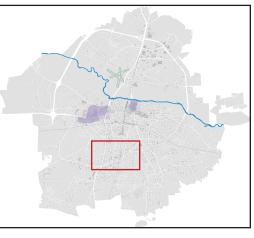

Date Revisions 5.01.08 12.21.09

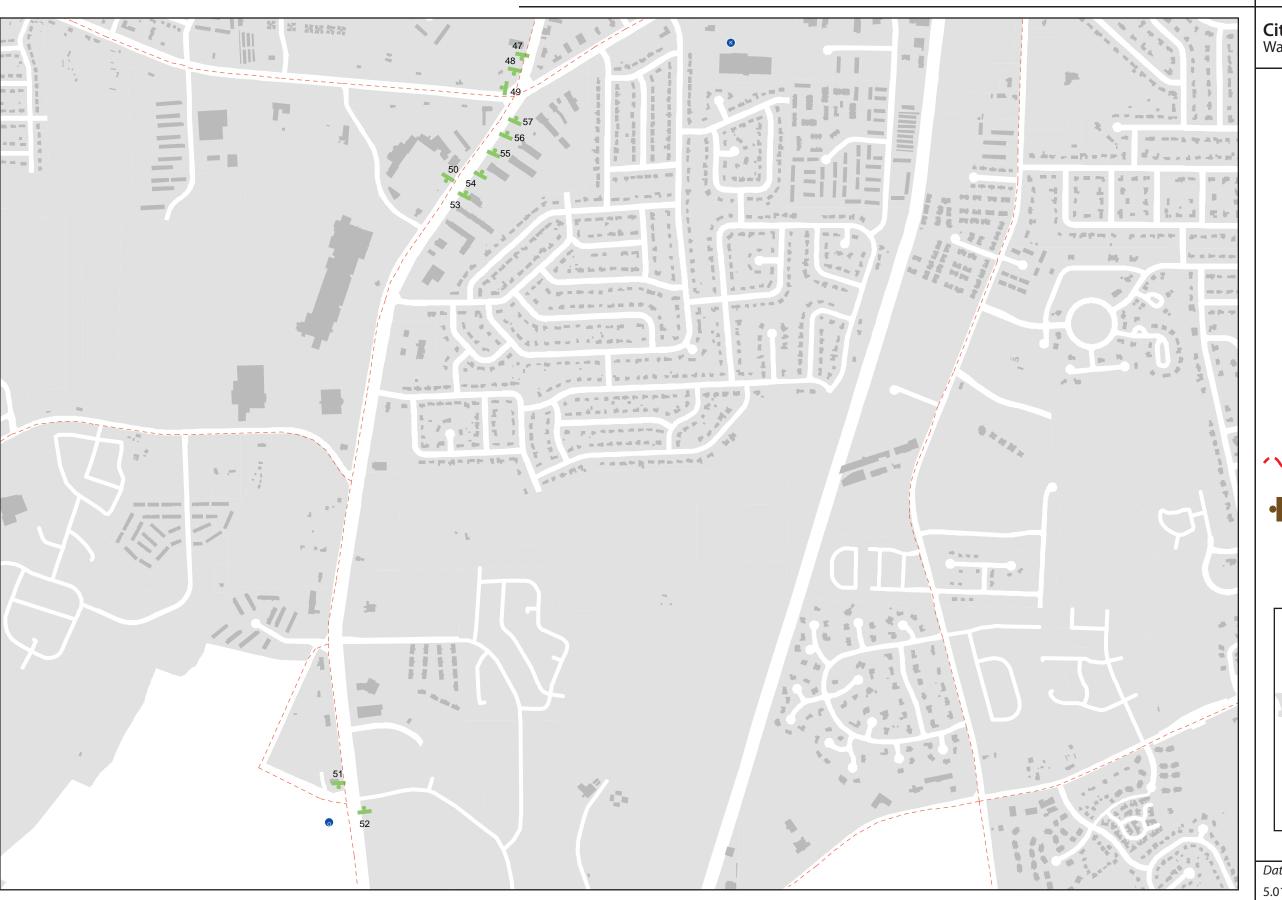


City of Greenville, NC Wayfinding Signing Program

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State-Maintained Road




Key Map

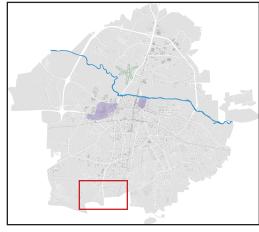

 Date
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 5.01.08
 12.21.09



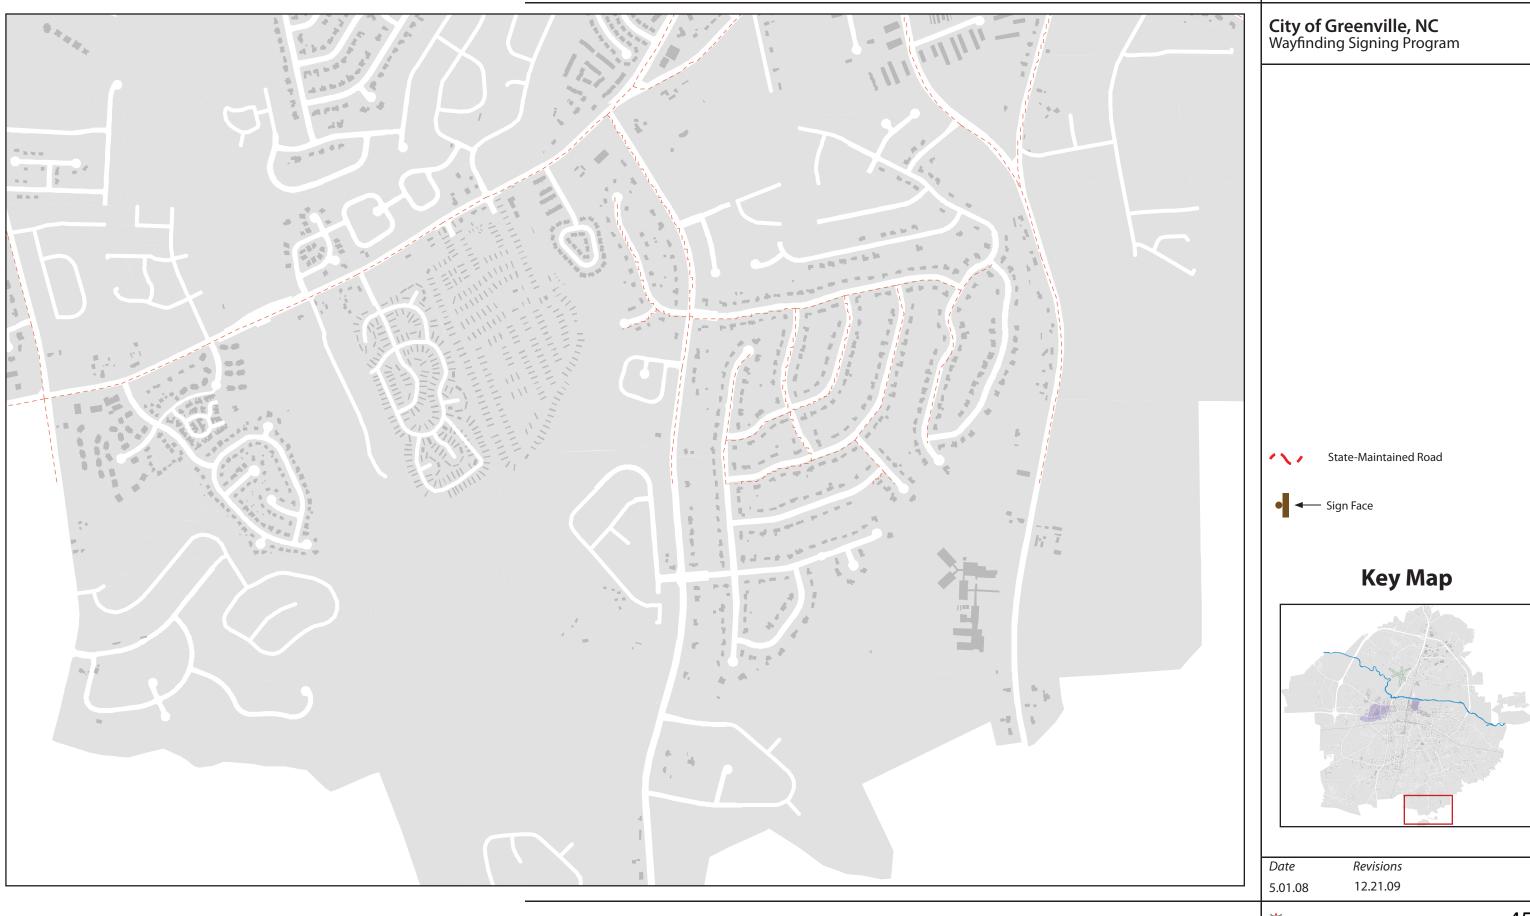







City of Greenville, NC Wayfinding Signing Program

































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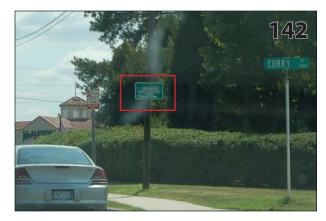
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